

LEXINGTON COMPOSTING FACILITY

2,141.48 (DC) SOLAR PHOTOVOLTAIC (PV) PROJECT

60 HARTWELL AVENUE LEXINGTON, MASSACHUSETTS 02421

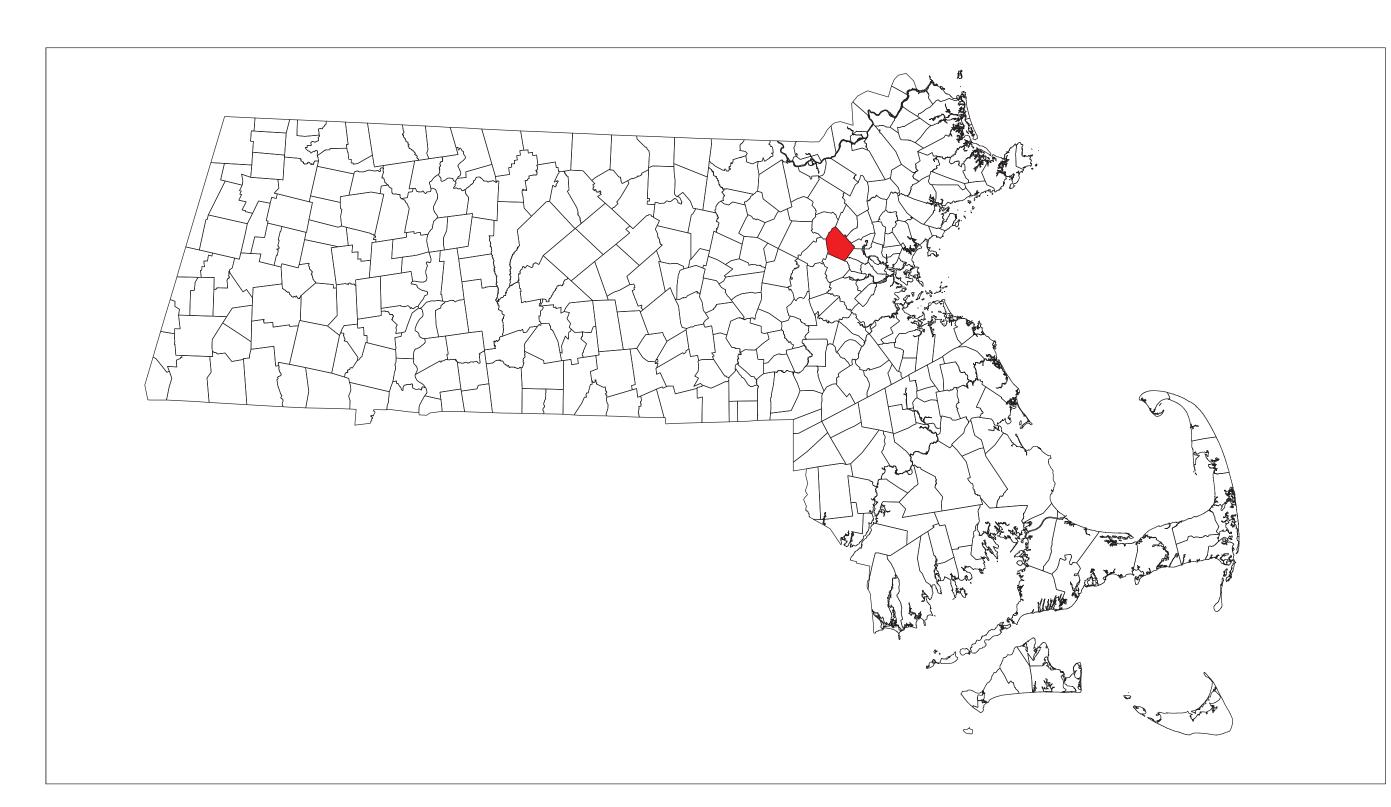

MASSACHUSETTS MUNICIPAL MAP SCALE: N.T.S.

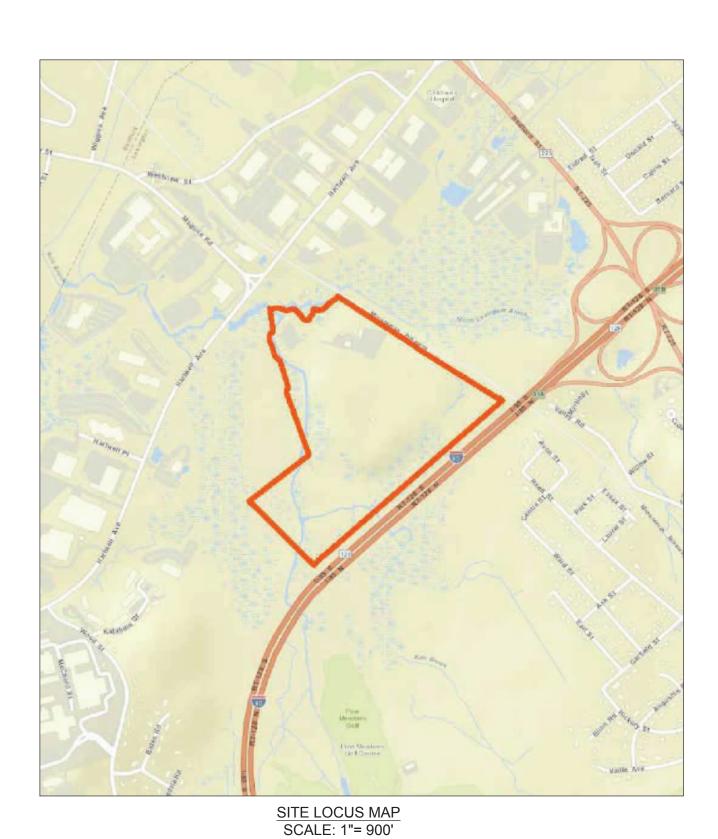

MNUTERAN COMMUTER BINEPATH

ROUTE VS. INTERSTREES

SITE LOCATION MAP (AERIAL VIEW) SCALE: 1"=400'

PROJECT	DIRECTORY
EVELOPER(S):	
RIGHTFIELDS DEVELOPMENT, LLC.	LANGDON ENVIRONMENTAL, LLC.
1 WALNUT STREET, SUITE 301	241 BOSTON POST ROAD, WEST
VELLESLEY, MASSACHUSETTS 19087	1ST FLOOR
	MARLBOROUGH, MASSACHUSETTS 01752
CONTACT: MIKE SINGER	
860) 214-7195	CONTACT: BRUCE HASKELL
	(508) 630-0351
SOLARCITY, INC.	
5 MEDFORD STREET, SUITE 306	ELECTRICAL ENGINEER:
SOMERVILLE, MASSACHUSETTS 02143	POWER ENGINEERS, LLC.
CONTACT: MILES HOVES	37 FOX DEN ROAD
CONTACT: MILES HOVIS 704) 813-4027	KINGSTON, MASSACHUSETTS 02364
704) 813-4027	CONTACT: DAVID COLOMBO, PE
IOST:	(508) 612-0382
OWN OF LEXINGTON	(000) 012 0002
625 MASSACHUSETTS AVE.	UTILITY:
EXINGTON, MASSACHUSETTS 02420	EVERSOURCE
	ONE NSTAR WAY
CONTACT: BILL HADLEY	WESTWOOD, MASSACHUSETTS 02090
781) 274-8300	
	CONTACT: BRIAN ROONEY
NGINEER(S):	(781) 441-3409
VESTON & SAMPSON ENGINEERS, INC.	
CENTENNIAL DRIVE	
EABODY, MASSACHUSETTS 01960	
CONTACT: STEPHEN WIEHE, PG	
978) 532-1900	
,	

DRAWING INDEX			
SHEET	SHEET TITLE		
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G-2	NOTES, LEGENDS, AND ABBREVIATIONS II		
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SOLAR PHOTOVOLTAIC (PV) SYSTEM DESCRIPTION			
SYSTEM	LOWER CANOPY	UPPER CANOPY	GROUND MOUNTED ARRAY
SYSTEM SIZE	442.68 kW (DC)	426.56 kW (DC)	1,272.24 kW (DC)
MODULE	(1,428) TRINA SOLAR TSM-PD14 (310W)	(1,376) TRINA SOLAR TSM-PD14 (310W)	(4,104) TRINA SOLAR TSM-PD14 (310W)
TILT ANGLE	5 DEGREES	5 DEGREES	20 DEGREES
AZIMUTH	±219 DEGREES	±197 DEGREES	180 DEGREES (SOUTH)
RACKING	SOLAIRE GENERATION LONG SPAN 360S CARPORT	SOLAIRE GENERATION LONG SPAN 360S CARPORT	GAMECHANGE RACKING (BALLASTED)

	SITE INFORMATION AND ZONIN	NG TABLE (SEE NOTE 1)	
OWNER:	TOWN OF LEXINGTON	EXISTING LAND USE:	
MAP-PARCEL	79-50	COMPOSTING OPERATION / CLOSED LANDFILL	
ZONING:		OVERLAY ZONING DISTRICT:	
MANUFACTURING (CM)		TRANSPORTATION MANAGEMENT (TMO)	
REGULATION REQUIREMENTS	CM	EXISTING	PROPOSED
MIN. LOT AREA (AC.)	3	67.84	N/A
MIN. FRONT YARD SETBACK (FT.)	25	N/A	N/A
MIN. SIDEYARD SETBACK (FT.)	25	5	5
MIN. REARYARD SETBACK (FT.)	25	391	428
MAX. SITE COVERAGE	NO REQUIREMENT	N/A	N/A
MAX. BUILDING HEIGHT (FT.)	65	<65	<65
AREA IN VEGETATED WETLAND (AC.)	N/A	33.39	33.39
DEVELOPABLE SITE AREA (AC.)	N/A	25.82	25.82
LENGTH OF STREET & AREA WITHIN STREET ROW (FT.)	N/A	N/A	N/A
AREA IN COMMON OPEN SPACE (AC.)	N/A	N/A	N/A
AREA & PERCENTAGE OF SITE COVERAGE OF BUILDINGS (SF. / %)	N/A	9,381 / 0.3	5,743 / 0.1
AREA COVERED WITH IMPERVIOUS SURFACE (AC.)	N/A	23.05	23.05
IMPERVIOUS SURFACE RATIO (%)	N/A	33	33
GROSS FLOOR AREA & NET FLOOR AREA OF ALL NON-RESIDENTIAL BUILDINGS (S.F.)	N/A	9,381	9,381
FLOOR AREA RATIO OF ALL NON-RESIDENTIAL BUILDINGS (%)	N/A	.3	.3
DENSITY OF DWELLING UNITS; OR EQUIVALENT (%)	N/A	N/A	N/A
NUMBER OF OFF-STREET PARKING SPACES AND LOADING BAYS	N/A	N/A	N/A

NOTES:

1. EXISTING CONDITIONS AND SITE INFORMATION FROM PLANS REFERENCED ON SHEET C-2, CHAPTER 135 SECTION 77 OF THE TOWN OF LEXINGTON ZONING BY-LAW (DATED APRIL 2015), TOWN OF LEXINGTON 2015 ZONING MAP (DATED JUNE 2015), AND THE TOWN OF LEXINGTON INTERACTIVE GEOGRAPHIC INFORMATION SYSTEMS (GIS) VIEWER. ALL QUANTITIES APPROXIMATE.

Project:

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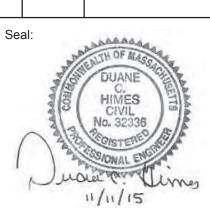




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	Rev	Date	Description
	<u>1</u>	11.12.15	CON, COMM, COMMENTS



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JOB NO. 2150511

10.12.2015

Scale: AS SHOWN

Drawn By: MSS

Reviewed By: MSS

Checked By: DCH

Drawing Title:

COVER SHEET

Sheet Number:

I-1

DESCRIPTION	EXISTING	PROPOSE
CATCH BASIN		III C
HYDRANT	~	+
UTILITY POLE	D	•
LIGHT POST	\$	
EDGE OF PAVEMENT		
EDGE OF UNPAVED ROAD		
GAS LINE	—— G——	
RAILROAD	+++++	
STONE WALL	000000000	~~~~~
RETAINING WALL		
FENCE	xx	xx
INDIVIDUAL DECIDUOUS TREE	\Diamond	0
INDIVIDUAL EVERGREEN TREE	*	*
EDGE OF WOODS	Luuu	~~~
DEBRIS / SOIL PILE / RUBBLE		
ELECTRIC METER		
SURVEY MARKER	•	
PROPERTY BOUNDARY		
APPROXIMATE LIMIT OF WASTE		
SPOT ELEVATIONS	×	×
DEPRESSION CONTOUR LINES	· · · · · · · · · · · · · · · · · · ·	<u> </u>
RESOURCE FLAG	ĭ TOB/BVW	,
GUY WIRE	⊕ -	
EROSION CONTROL MATTING		XXXXX
RIP RAP	****	}
SIGN		HAHAH
BENCH MARK	<u> </u>	
AUGER BORING	\oplus	\oplus
PERCOLATION TEST		•
TEST PIT		
SOIL BORING	•	
HIGH POINT	HP HP	
BLIND FLANGE	—H	
GAS CONDENSATE KNOCKOUT	<u> </u>	
CONTROL VALVE	\bigcirc	
BAR HOLE PROBE (LANDFILL GAS MONITORING))	
POLYVINYL CHLORIDE (PIPE)	PVC	
CONCRETE	P V C	
PAVEMENT		
NOW OR FORMERLY	N/F	
SURFACE WATER SAMPLING LOCATION	⇒SW	
GROUNDWATER MONITORING WELL		
EXISTING WELL	S-SHALLOW D-DEEP	
GAS EXTRACTION WELL	⊕ #2 □	
SOIL GAS MONITORING POINT	→ GP	
GAS VENT		
SEDIMENT/EROSION CONTROLS	\bigcirc	
ROCK OUTCROP		
PHASE BOUNDARY		
SEWER MANHOLE	6	
MANHOLE (MH) FOR UNDERDRAIN SYSTEM	<u>(S)</u>	
DRAIN MANHOLE (DMH)	© ©	
STAFF GAUGE	©	
	\bigcirc	F •
GRASS SWALE		, , , ,
SIDE SLOPE SWALE		
END CAP		0—
UTILITY MANHOLE	0	
PV MODULE RACK		
OVERHEAD WIRE	OH	
RIVER FRONT AREA BUFFER		
BORDERED VEGETATED WETLAND BUFFER		

CONSTRUCTION NOTES:

- 1. THE CONTRACTOR SHALL CALL DIGSAFE AT 811 OR 1-888-344-7233 AT LEAST 72 HOURS, SATURDAYS, SUNDAYS, AND HOLIDAYS EXCLUDED, PRIOR TO EXCAVATING AT ANY LOCATION. A COPY OF THE DIGSAFE PROJECT REFERENCE NUMBER(S) SHALL BE GIVEN TO THE OWNER PRIOR TO EXCAVATION.
- 2. LOCATIONS OF EXISTING PIPES, CONDUITS, UTILITIES, FOUNDATIONS AND OTHER UNDERGROUND OBJECTS ARE NOT WARRANTED TO BE CORRECT AND THE CONTRACTOR SHALL HAVE NO CLAIM ON THAT ACCOUNT SHOULD THEY BE OTHER
- 3. STONE WALLS, FENCES, CURBS, ETC. SHALL BE REMOVED AND REPLACED AS NECESSARY TO PERFORM THE WORK. UNLESS OTHERWISE INDICATED, ALL SUCH WORK SHALL BE INCIDENTAL TO CONSTRUCTION OF THE PROJECT.
- 4. ALL AREAS DISTURBED BY THE CONTRACTOR BEYOND PAYMENT LIMITS SHALL BE RESTORED AT NO ADDITIONAL COST TO THE OWNER.

SPECIFICATIONS FOR WORK ON LANDFILL:

GENERAL:


- 1. THE CONTRACTOR SHALL BE AWARE THAT WORK IS LOCATED ON A LANDFILL AND IS SUBJECT TO THE MASSACHUSETTS CONTINGENCY PLAN (MCP), 310 CMR 40.0000. THE LANDFILL WAS CLOSED WITH AN ACTIVITY AND USE LIMITATION (RELEASE TRACKING NUMBER 3-21522) UNDER THE MCP IN 2009.
- 2. THE CONTRACTOR SHALL BE AWARE THAT THE WORK IS TO TAKE PLACE ON TOP OF A LANDFILL, WHICH WAS CAPPED WITH 2 FEET OF SOIL FOLLOWED BY MISCELLANEOUS DEPARTMENT OF PUBLIC WORKS (DPW) MATERIALS TO APPROXIMATELY 10 TO 15 FEET ABOVE THE MUNICIPAL SOLID WASTE.
- 3. WORK SHALL BE COMPLETED IN GENERAL ACCORDANCE WITH THE MASSACHUSETTS DEPARTMENT OF ENVIRONMENTAL PROTECTION'S MCP PROTOCOL.
- 4. THE CONTRACTOR SHALL HAVE A HEALTH AND SAFETY PLAN WHILE WORKING ON THE LANDFILL.

EXCAVATIONS:

- 1. THE CONTRACTOR SHALL PROVIDE AN EXCAVATION PLAN DETAILING HOW THE CONTRACTOR WILL COMPLY WITH ALL PERTINENT PROVISIONS OF THE CONTRACT DOCUMENTS, INCLUDING SITE RESTRICTIONS, WORK PROTOCOLS, TEMPORARY ROADS, ON-SITE PARKING AND STORAGE AREAS.
- 2. EXCAVATIONS ON THE LANDFILL AREA SHALL BE PERFORMED WITH THE GUIDANCE OF A LABORER OR 'SPOTTER' AT ALL TIMES. THE LABORER SHALL IDENTIFY THE DEPTH OF THE WASTE AND NOTIFY THE OPERATOR SHOULD HE/SHE GET TOO CLOSE TO THE WASTE.

TEMPORARY EROSION CONTROL MEASURES:


- 1. EROSION CONTROL MEASURES SHALL BE IMPLEMENTED AS DETERMINED BY THE ON-SITE ENGINEER.
- THE SMALLEST PRACTICAL AREA OF LAND SHALL BE EXPOSED AT ANY ONE TIME.
- 3. EROSION/SEDIMENT CONTROL MEASURES SHALL BE INSTALLED AS SHOWN ON PLANS. EROSION CONTROL BARRIERS ARE TO BE MAINTAINED AND CLEANED UNTIL ALL AREAS HAVE BEEN ADEQUATELY STABILIZED.
- 4. THE TEMPORARY AND PERMANENT STORMWATER CONTROLS SHALL BE PERIODICALLY CLEANED OF SEDIMENT, AS REQUIRED BY THE ENGINEER. THE SEDIMENT WILL BE REMOVED TO A SECURE LOCATION SO AS TO PREVENT SILTATION OF NATURAL WATER WAYS.
- 5. SILT SOCK FILLED WITH COMPOST MUST BE A MINIMUM TUBE DIAMETER OF 12 INCHES (300mm) FOR SLOPES UP TO 50 FEET (15.24m) IN LENGTH WITH A SLOPE RATIO OF 3H:1V OR STEEPER. LONGER SLOPES OF 3H:1V MAY REQUIRE LARGER TUBE DIAMETER OR ADDITIONAL COURSING OF FILTER TUBES TO CREATE A FILTER BERM. SILT SOCK TO BE MADE OF BIODEGRADABLE BURLAP. SILT SOCK TO BE SEDIMENT FILTERMITT OR APPROVED EQUAL. OTHER REFER TO MANUFACTURER'S RECOMMENDATIONS FOR INSTALLATION INSTRUCTIONS.
- 6. INSTALL SOCK ALONG CONTOURS AND PERPENDICULAR TO SHEET OR CONCENTRATED FLOW.
- 7. CONFIGURE SOCKS AROUND EXISTING SITE FEATURES TO MINIMIZE SITE DISTURBANCE AND MAXIMIZE CAPTURE AREA OF STORMWATER RUN-OFF.
- 8. EROSION CONTROL MEASURES SHALL BE REMOVED WHEN DISTURBED AREA IS STABILIZED. DISTURBED AREA RESULTING FROM THE MEASURE REMOVAL OPERATION SHALL BE SEEDED IN ACCORDANCE WITH THE SPECIFICATIONS.

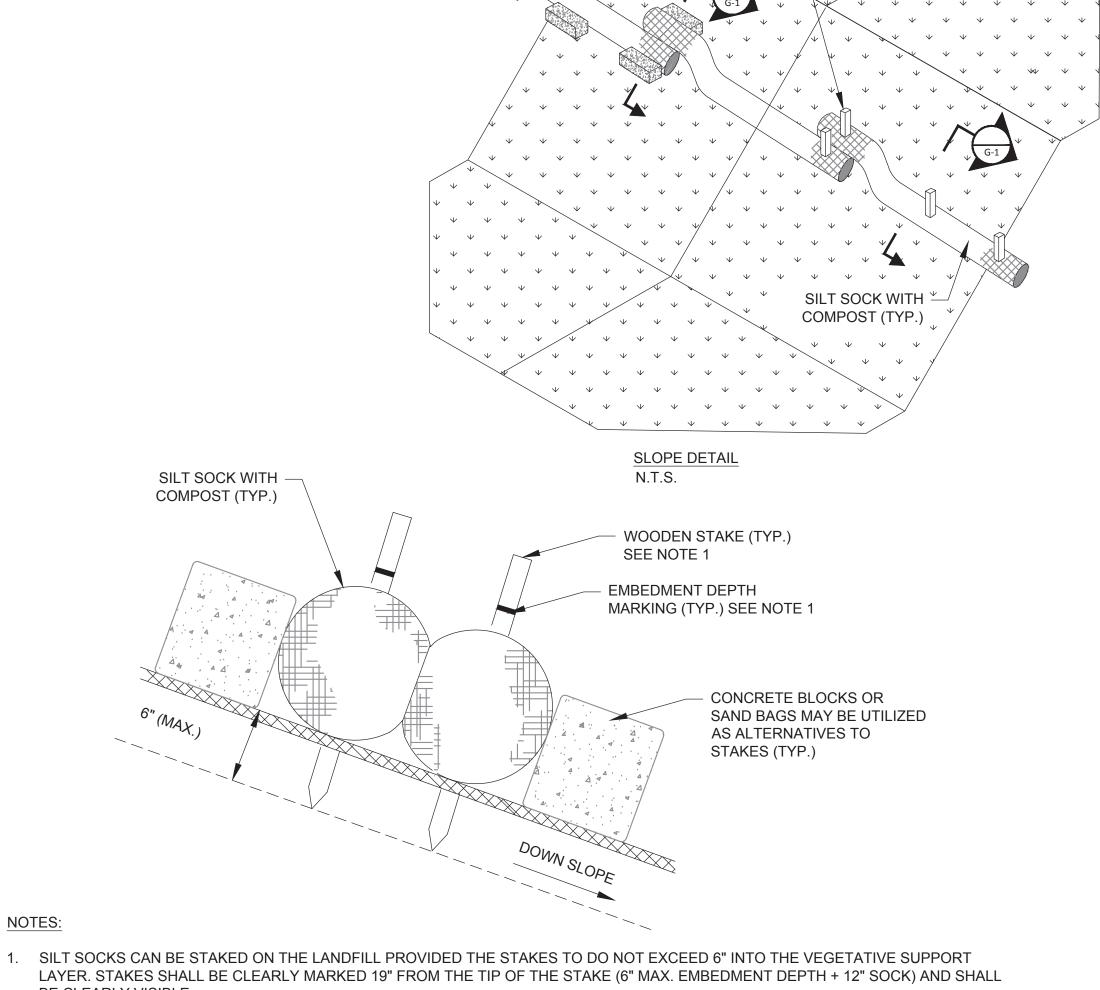

WOODEN STAKE (TYP.)

LAYER. STAKES SHALL BE CLEARLY MARKED 19" FROM THE TIP OF THE STAKE (6" MAX. EMBEDMENT DEPTH + 12" SOCK) AND SHALL BE CLEARLY VISIBLE.

SILT SOCK STAKE/BLOCK CROSS SECTION SCALE: N.T.S.

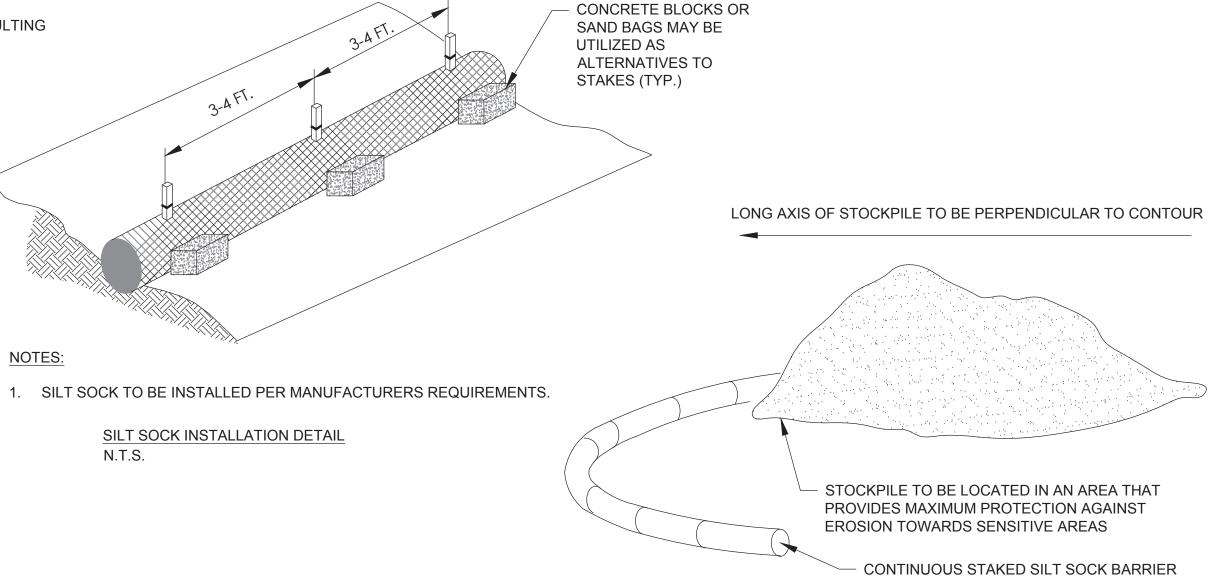

TEMPORARY STOCKPILE DETAIL SCALE: N.T.S.

PLACED DOWN GRADIENT OF STOCKPILE

LEXINGTON COMPOSTING FACILITY SOLAR PROJECT



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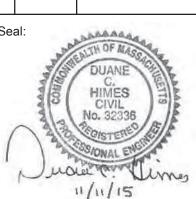
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NOTES, LEGENDS, AND **ABBREVIATIONS**

Sheet Number:

G-1

SEEDING WITHIN GROUND MOUNTED ARRAY AREA

NEW ENGLAND SEMI-SHADE GRASS AND FORBS MIX - THE NEW ENGLAND SEMI SHADE GRASS & FORB MIX CONTAINS A BROAD SPECTRUM OF NATIVE GRASSES AND FORBS THAT WILL TOLERATE SEMI-SHADE AND EDGE CONDITIONS. ALWAYS APPLY ON CLEAN BARE SOIL. THE MIX MAY BE APPLIED BY HYDRO-SEEDING, BY MECHANICAL SPREADER, OR ON SMALL SITES IT CAN BE SPREAD BY HAND. LIGHTLY RAKE, OR ROLL TO ENSURE PROPER SEED TO SOIL CONTACT. BEST RESULTS ARE OBTAINED WITH A SPRING SEEDING. LATE SPRING AND EARLY SUMMER SEEDING WILL BENEFIT WITH A LIGHT MULCHING OF WEED-FREE STRAW TO CONSERVE MOISTURE. IF CONDITIONS ARE DRIER THAN USUAL, WATERING WILL BE REQUIRED. LATE FALL AND WINTER DORMANT SEEDING REQUIRE AN INCREASE IN THE SEEDING RATE. FERTILIZER OR LIMING IS PROHIBITED, UNLESS PRIOR APPROVAL BY THE CONSERVATION COMMISSION. PREPARATION OF A CLEAN WEED FREE SEED BED IS NECESSARY FOR OPTIMAL RESULTS. APPLICATION RATE 30 POUNDS PER ACRE.


SEEDING WITHIN THE RIVERFRONT RESTORATION AREA (ADJACENT TO THE LOWER CANOPY)

NEW ENGLAND CONSERVATION/WILDLIFE MIX - THE NEW ENGLAND CONSERVATION/WILDLIFE MIX PROVIDES A PERMANENT COVER OF GRASSES, WILDFLOWERS, AND LEGUMES. FOR BOTH GOOD EROSION CONTROL AND WILDLIFE HABITAT VALUE. THE MIX IS DESIGNED TO BE A NO MAINTENANCE SEEDING, AND IS APPROPRIATE FOR CUT AND FILL SLOPES, DETENTION BASIN SIDE SLOPES, AND DISTURBED AREAS ADJACENT TO COMMERCIAL AND RESIDENTIAL PROJECTS. ALWAYS APPLY ON CLEAN BARE SOIL. THE MIX MAY BE APPLIED BY HYDRO-SEEDING, BY MECHANICAL SPREADER, OR ON SMALL SITES IT CAN BE SPREAD BY HAND. LIGHTLY RAKE, OR ROLL TO ENSURE PROPER SEED TO SOIL CONTACT. BEST RESULTS ARE OBTAINED WITH A SPRING SEEDING. LATE SPRING AND EARLY SUMMER SEEDING WILL BENEFIT WITH A LIGHT MULCHING OF WEED-FREE STRAW TO CONSERVE MOISTURE. IF CONDITIONS ARE DRIER THAN USUAL, WATERING WILL BE REQUIRED. LATE FALL AND WINTER DORMANT SEEDING REQUIRE AN INCREASE IN THE SEEDING RATE. FERTILIZER OR LIMING IS PROHIBITED, PRIOR APPROVAL FROM THE CONSERVATION COMMISSION. PREPARATION OF A CLEAN WEED FREE SEED BED IS NECESSARY FOR OPTIMAL RESULTS. APPLICATION RATE 25 POUNDS PER ACRE.

MAINTENANCE

MAINTENANCE OF SEEDED AREAS SHALL BE THE SOLE RESPONSIBILITY OF CONTRACTOR AS DESCRIBED BELOW:

- A. CONTRACTOR SHALL MAINTAIN THE ENTIRE SEEDED AREAS UNTIL FINAL ACCEPTANCE AT THE COMPLETION OF THE PROJECT OR FOR 90 DAY, WHICHEVER IS LONGER. MAINTENANCE SHALL INCLUDE WATERING AS SPECIFIED, WEEDING, REMOVAL OF STONES WHICH MAY APPEAR AND REGULAR CUTTINGS OF THE GRASS NO CLOSER THAN 10 DAYS APART. THE FIRST CUTTING SHALL BE ACCOMPLISHED WHEN THE GRASS IS FROM 2-1/2 TO 3 INCHES HIGH. WEEKLY WATERING SHALL PROVIDE THE SEEDED AREAS WITH THE EQUIVALENT OF 1 INCH OF RAINFALL PER WEEK. IF THE SEEDED AREAS ARE WATERED BY NORMAL RAINFALL OR THE NORMAL WATERING IS INADEQUATE DUE TO WEATHER, THE CONTRACTOR MAY AT HIS/HER DISCRETION ELIMINATE OR INCREASE RESPECTIVELY, THE WATERING DURING A GIVEN WEEK. HOWEVER, SUCH ACTION BY CONTRACTOR SHALL IN NO WAY WAIVE CONTRACTOR'S RESPONSIBILITY FOR THE GROWTH AND HEALTH OF THE GRASS UNTIL FINAL ACCEPTANCE. CONTRACTOR SHALL FURNISH ALL TEMPORARY PIPE AND CONNECTIONS FOR SPRINKLING. CONTRACTOR SHALL FURNISH ALL REQUIRED WATER AT NO EXPENSE TO THE OWNER. GARDEN HOSE AND HAND SPRINKLING SHALL BE PERMITTED ONLY IN SPECIAL INSTANCES BY THE OWNER'S REPRESENTATIVE.
- B. ALL BARE SPOTS, WHICH BECOME APPARENT AS THE GRASS GERMINATES, SHALL BE RESEEDED BY CONTRACTOR AT ITS OWN EXPENSE AS MANY TIMES AS NECESSARY TO SECURE A GOOD GROWTH AND THE ENTIRE AREA SHALL BE MAINTAINED AND CUT UNTIL ALL WORK HAS BEEN COMPLETED AND FINAL ACCEPTANCE HAS OCCURRED.
- C. CONTRACTOR SHALL TAKE WHATEVER MEASURES ARE NECESSARY TO PROTECT THE GRASS WHILE IT IS GERMINATING. THESE MEASURES SHALL INCLUDE FURNISHING OF WARNING SIGNS, BARRIERS, TEMPORARY FENCE OR ANY OTHER NECESSARY MEASURES OF PROTECTION.
- O. CONTRACTOR SHALL FURNISH, PROTECT, AND MAINTAIN ALL TEMPORARY BARRIERS UNTIL FINAL ACCEPTANCE OF THE SEEDED AREAS BY THE OWNER AND SHALL REMOVE THEM UPON SUCH FINAL ACCEPTANCE, THE BARRIERS SHALL REMAIN THE PROPERTY OF CONTRACTOR AT ALL TIMES.

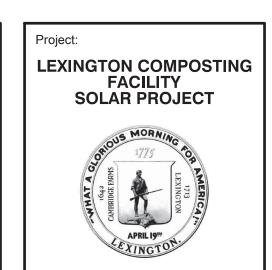

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DEVELOPMENT LLC

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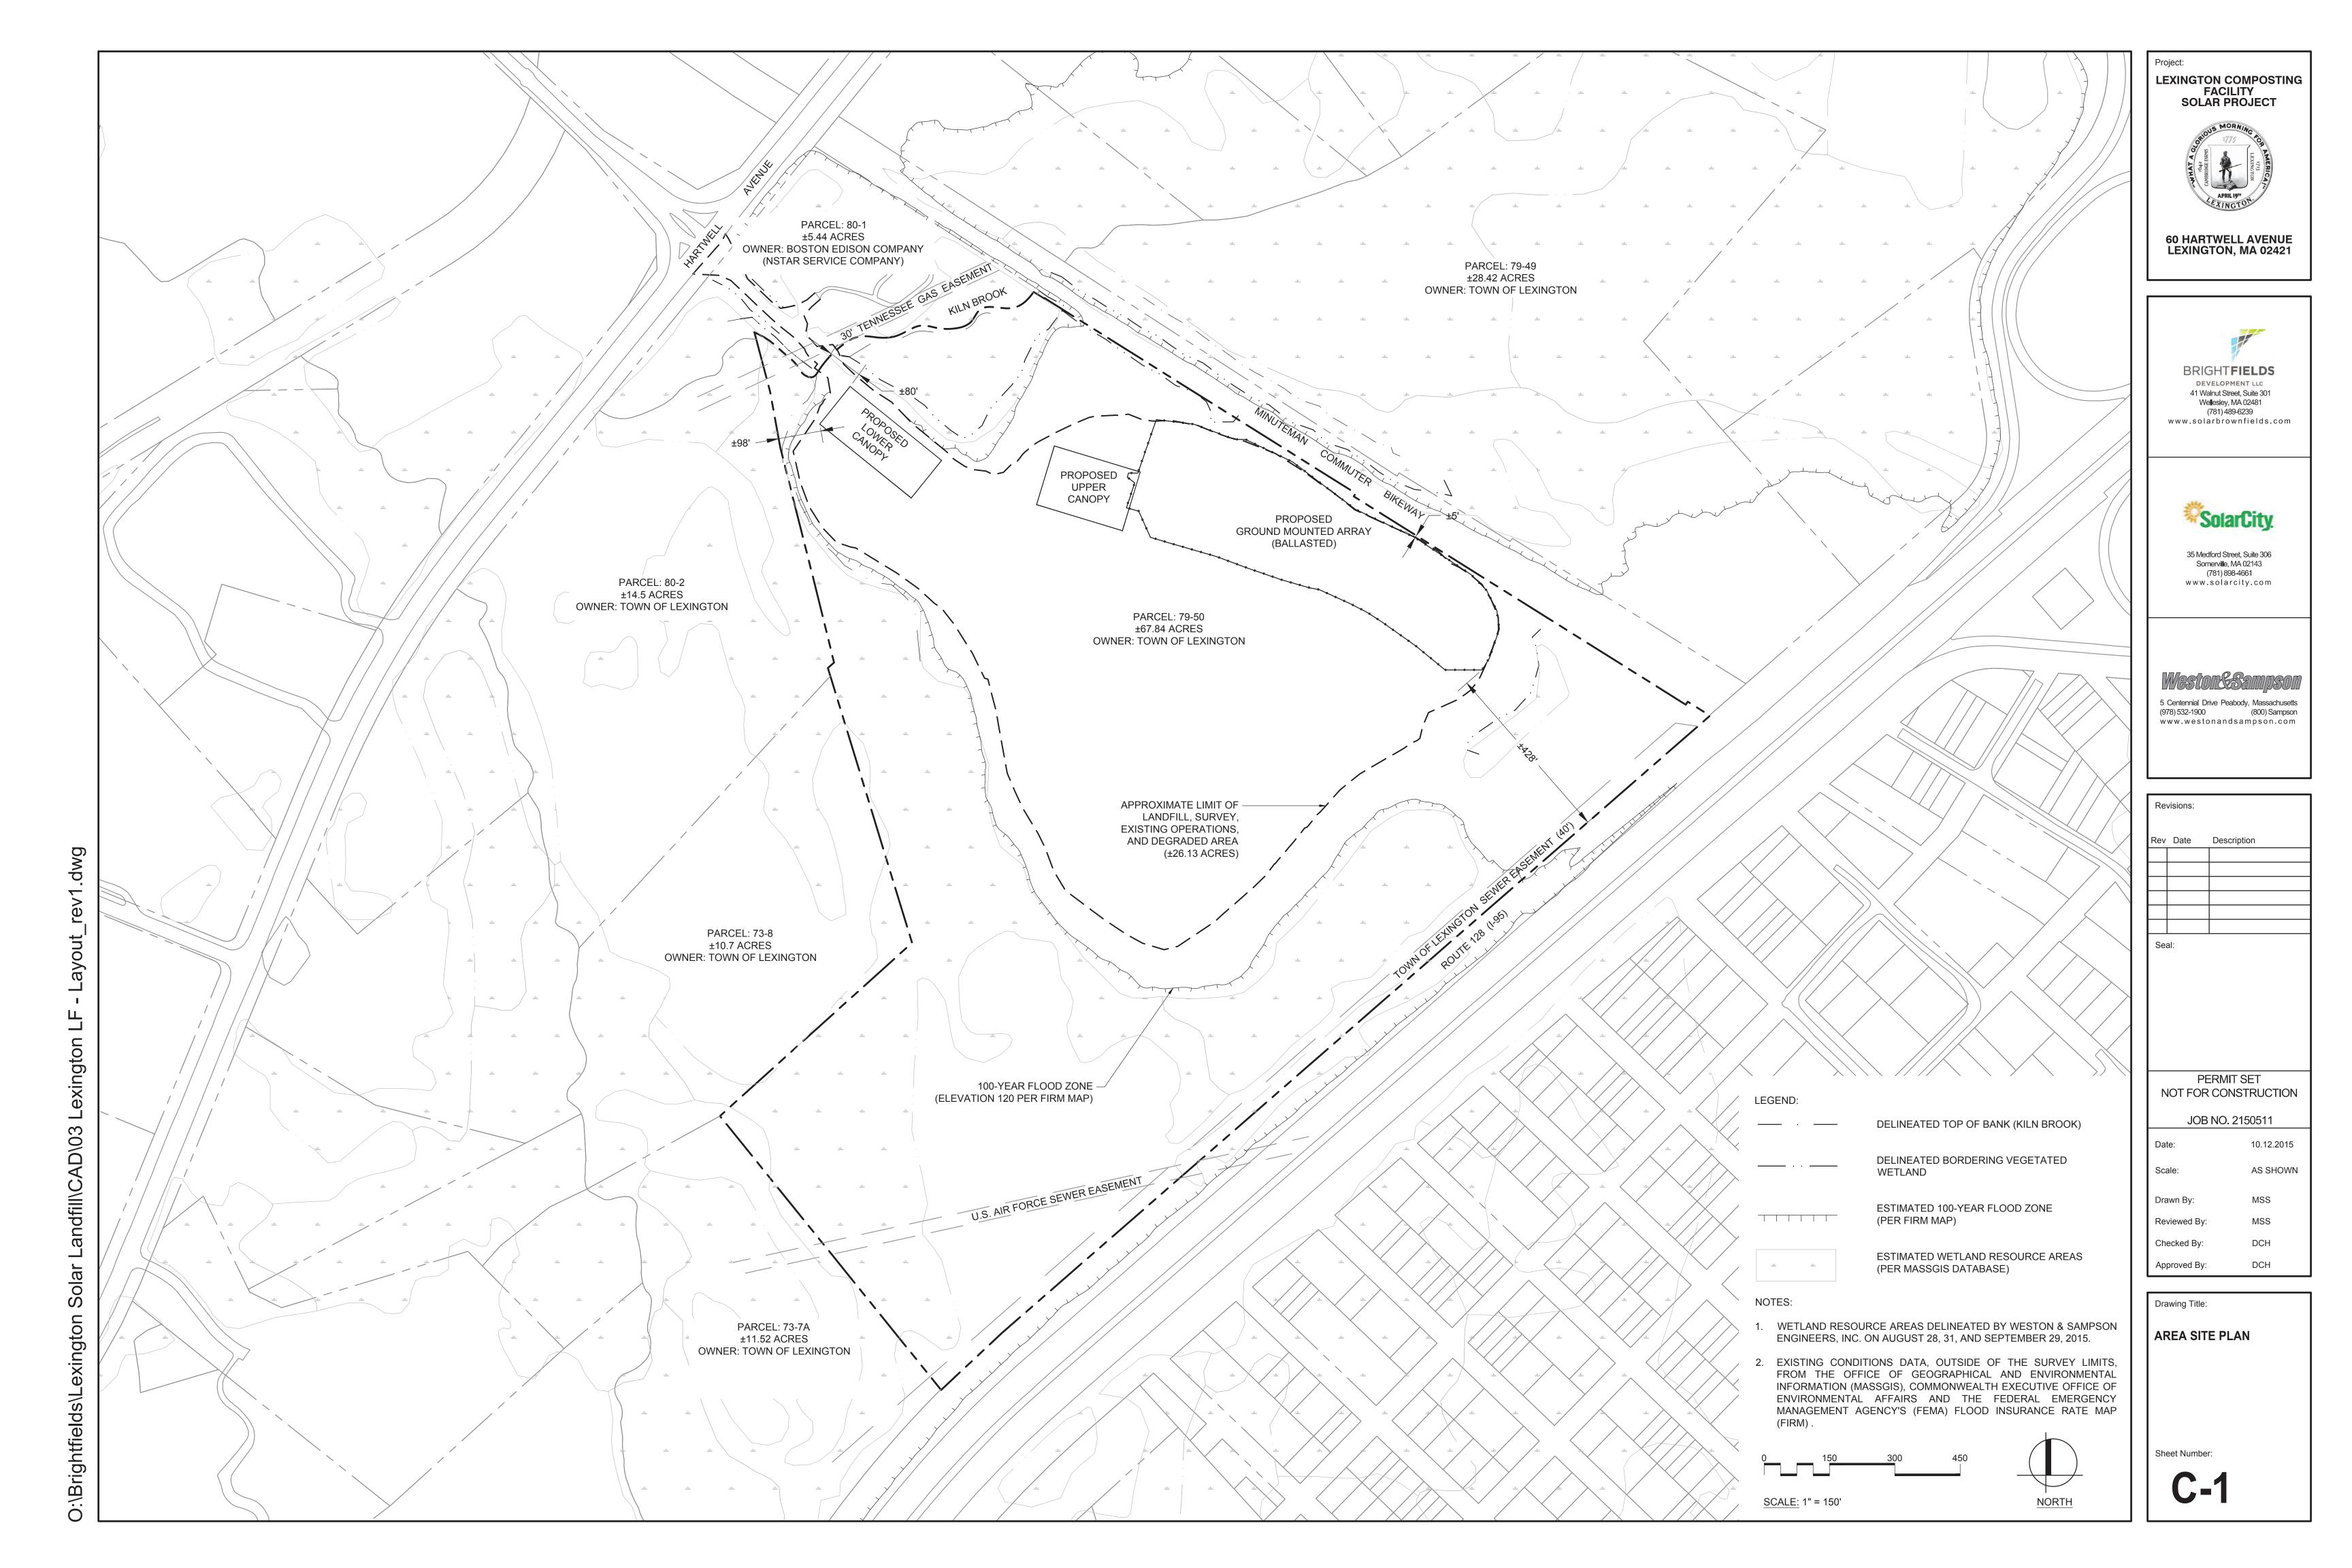
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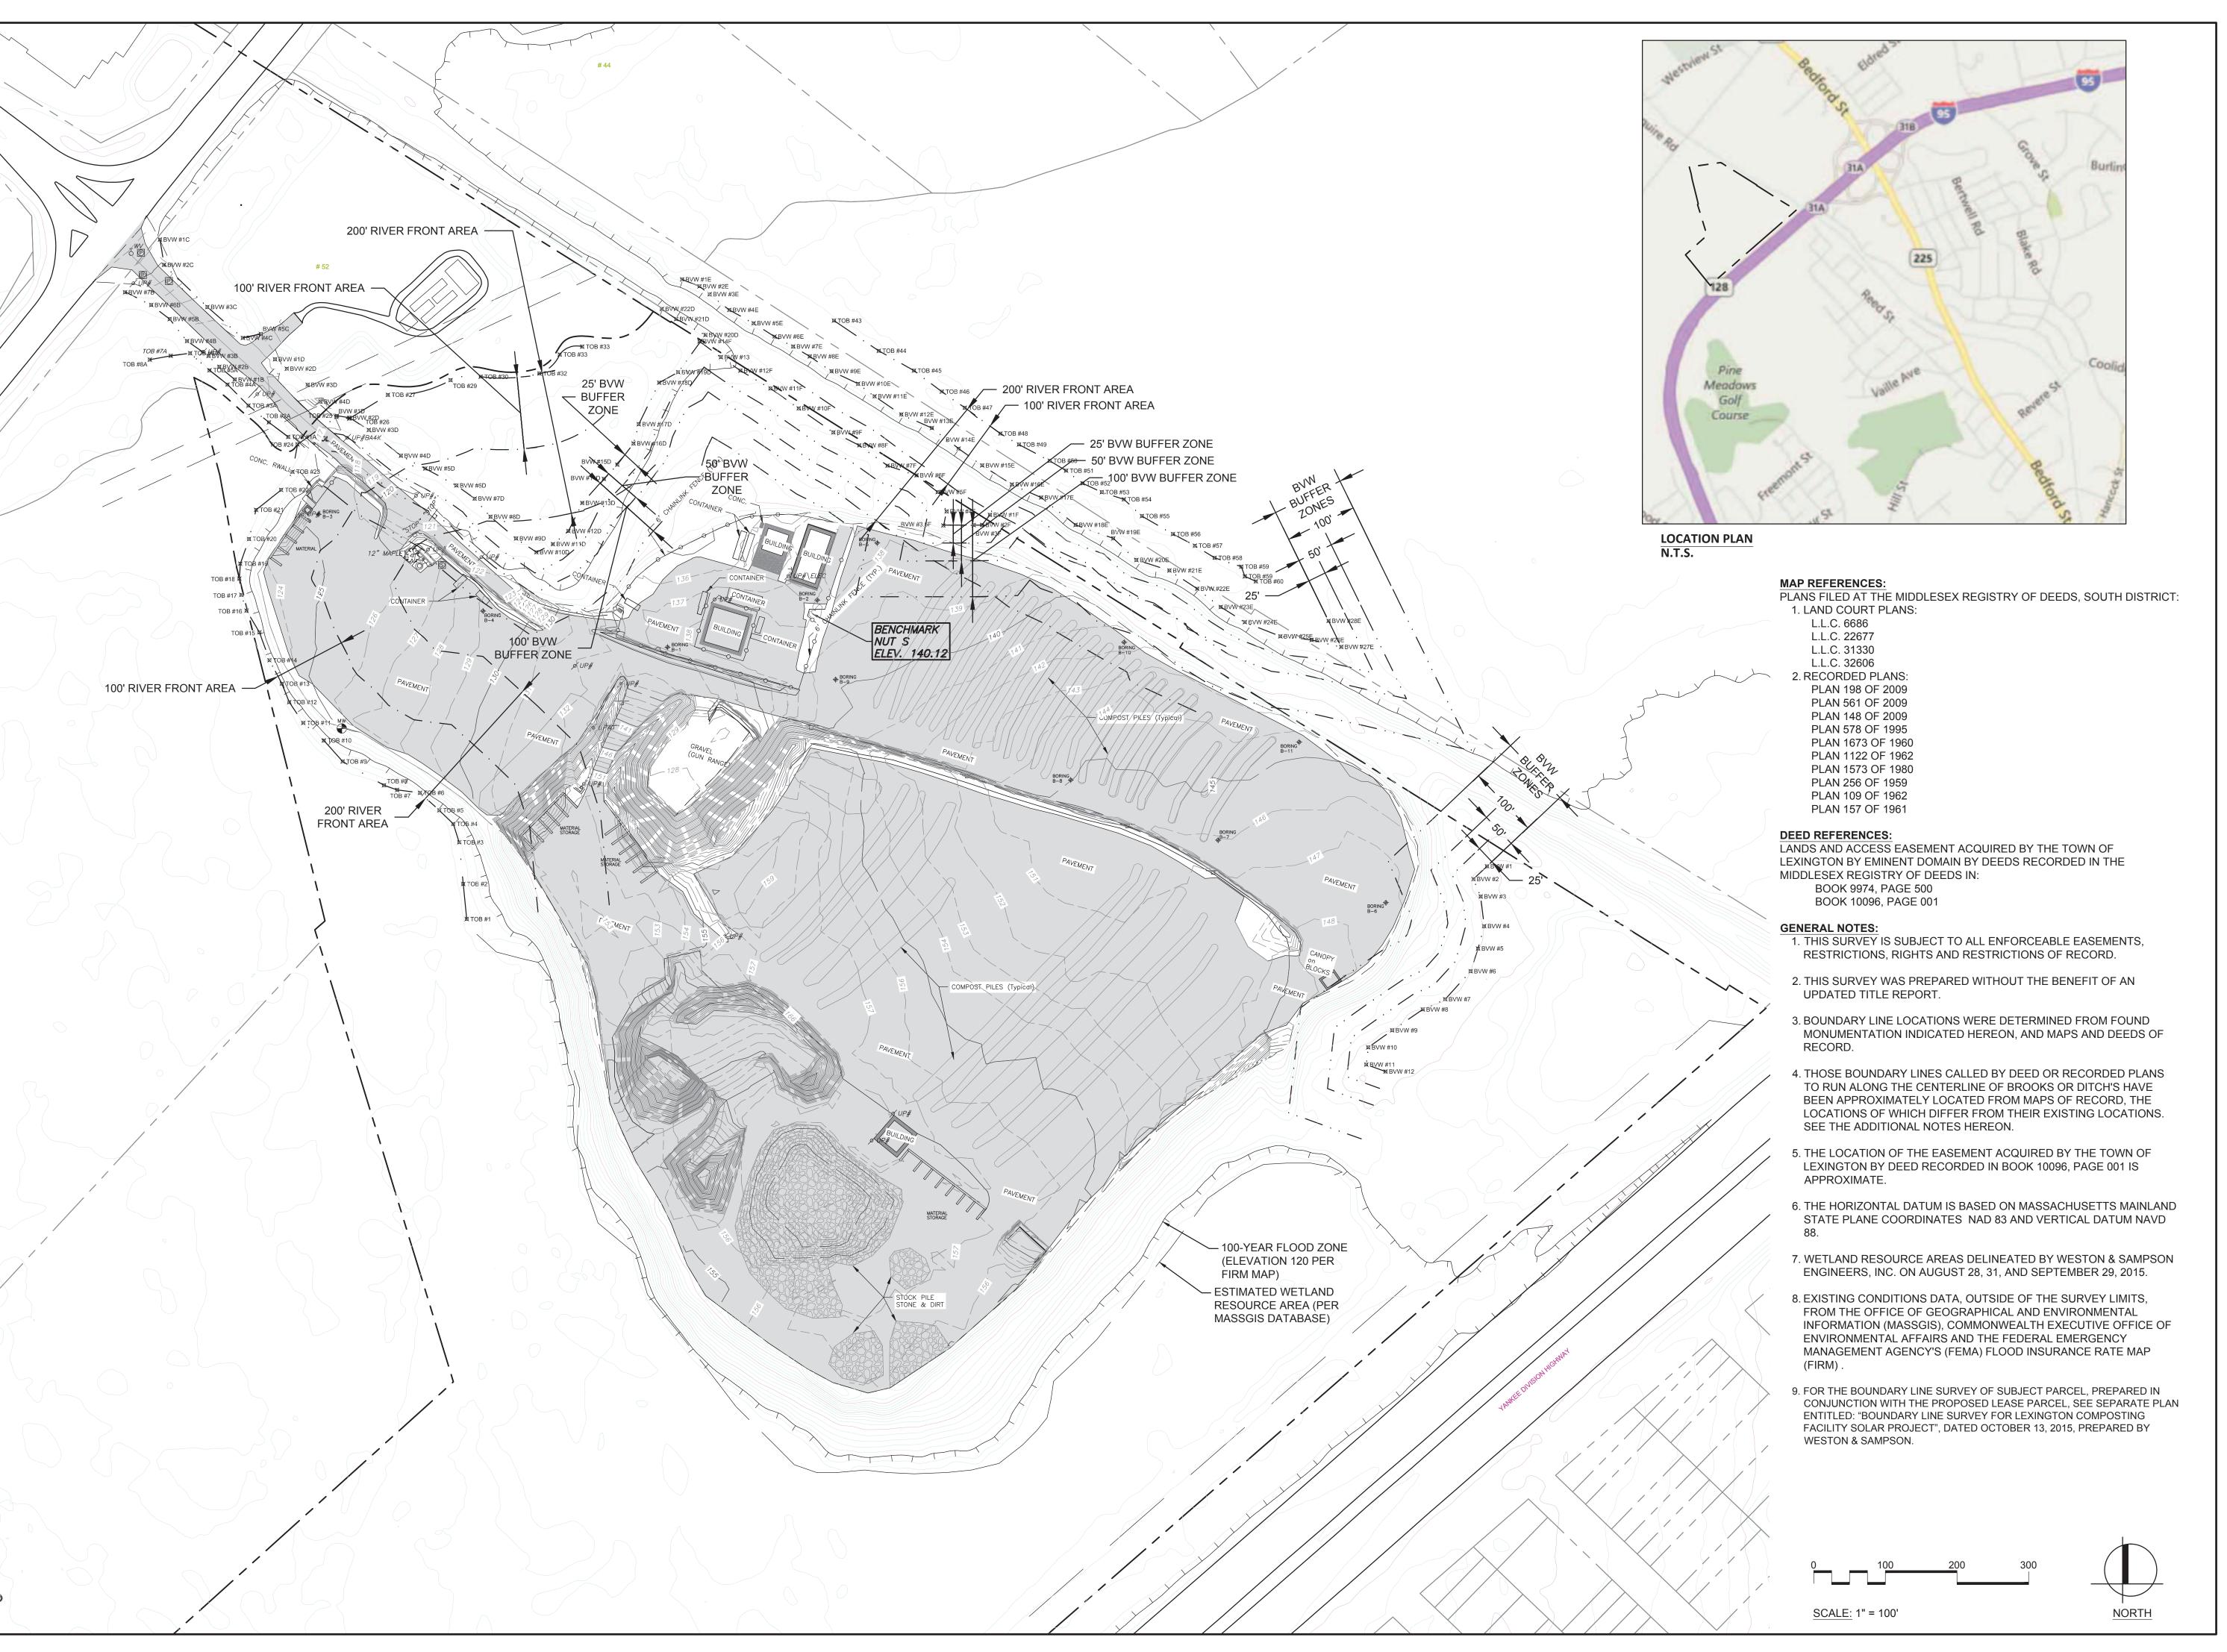
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NOTES, LEGENDS, AND ABBREVIATIONS II

Sheet Number:

G-2





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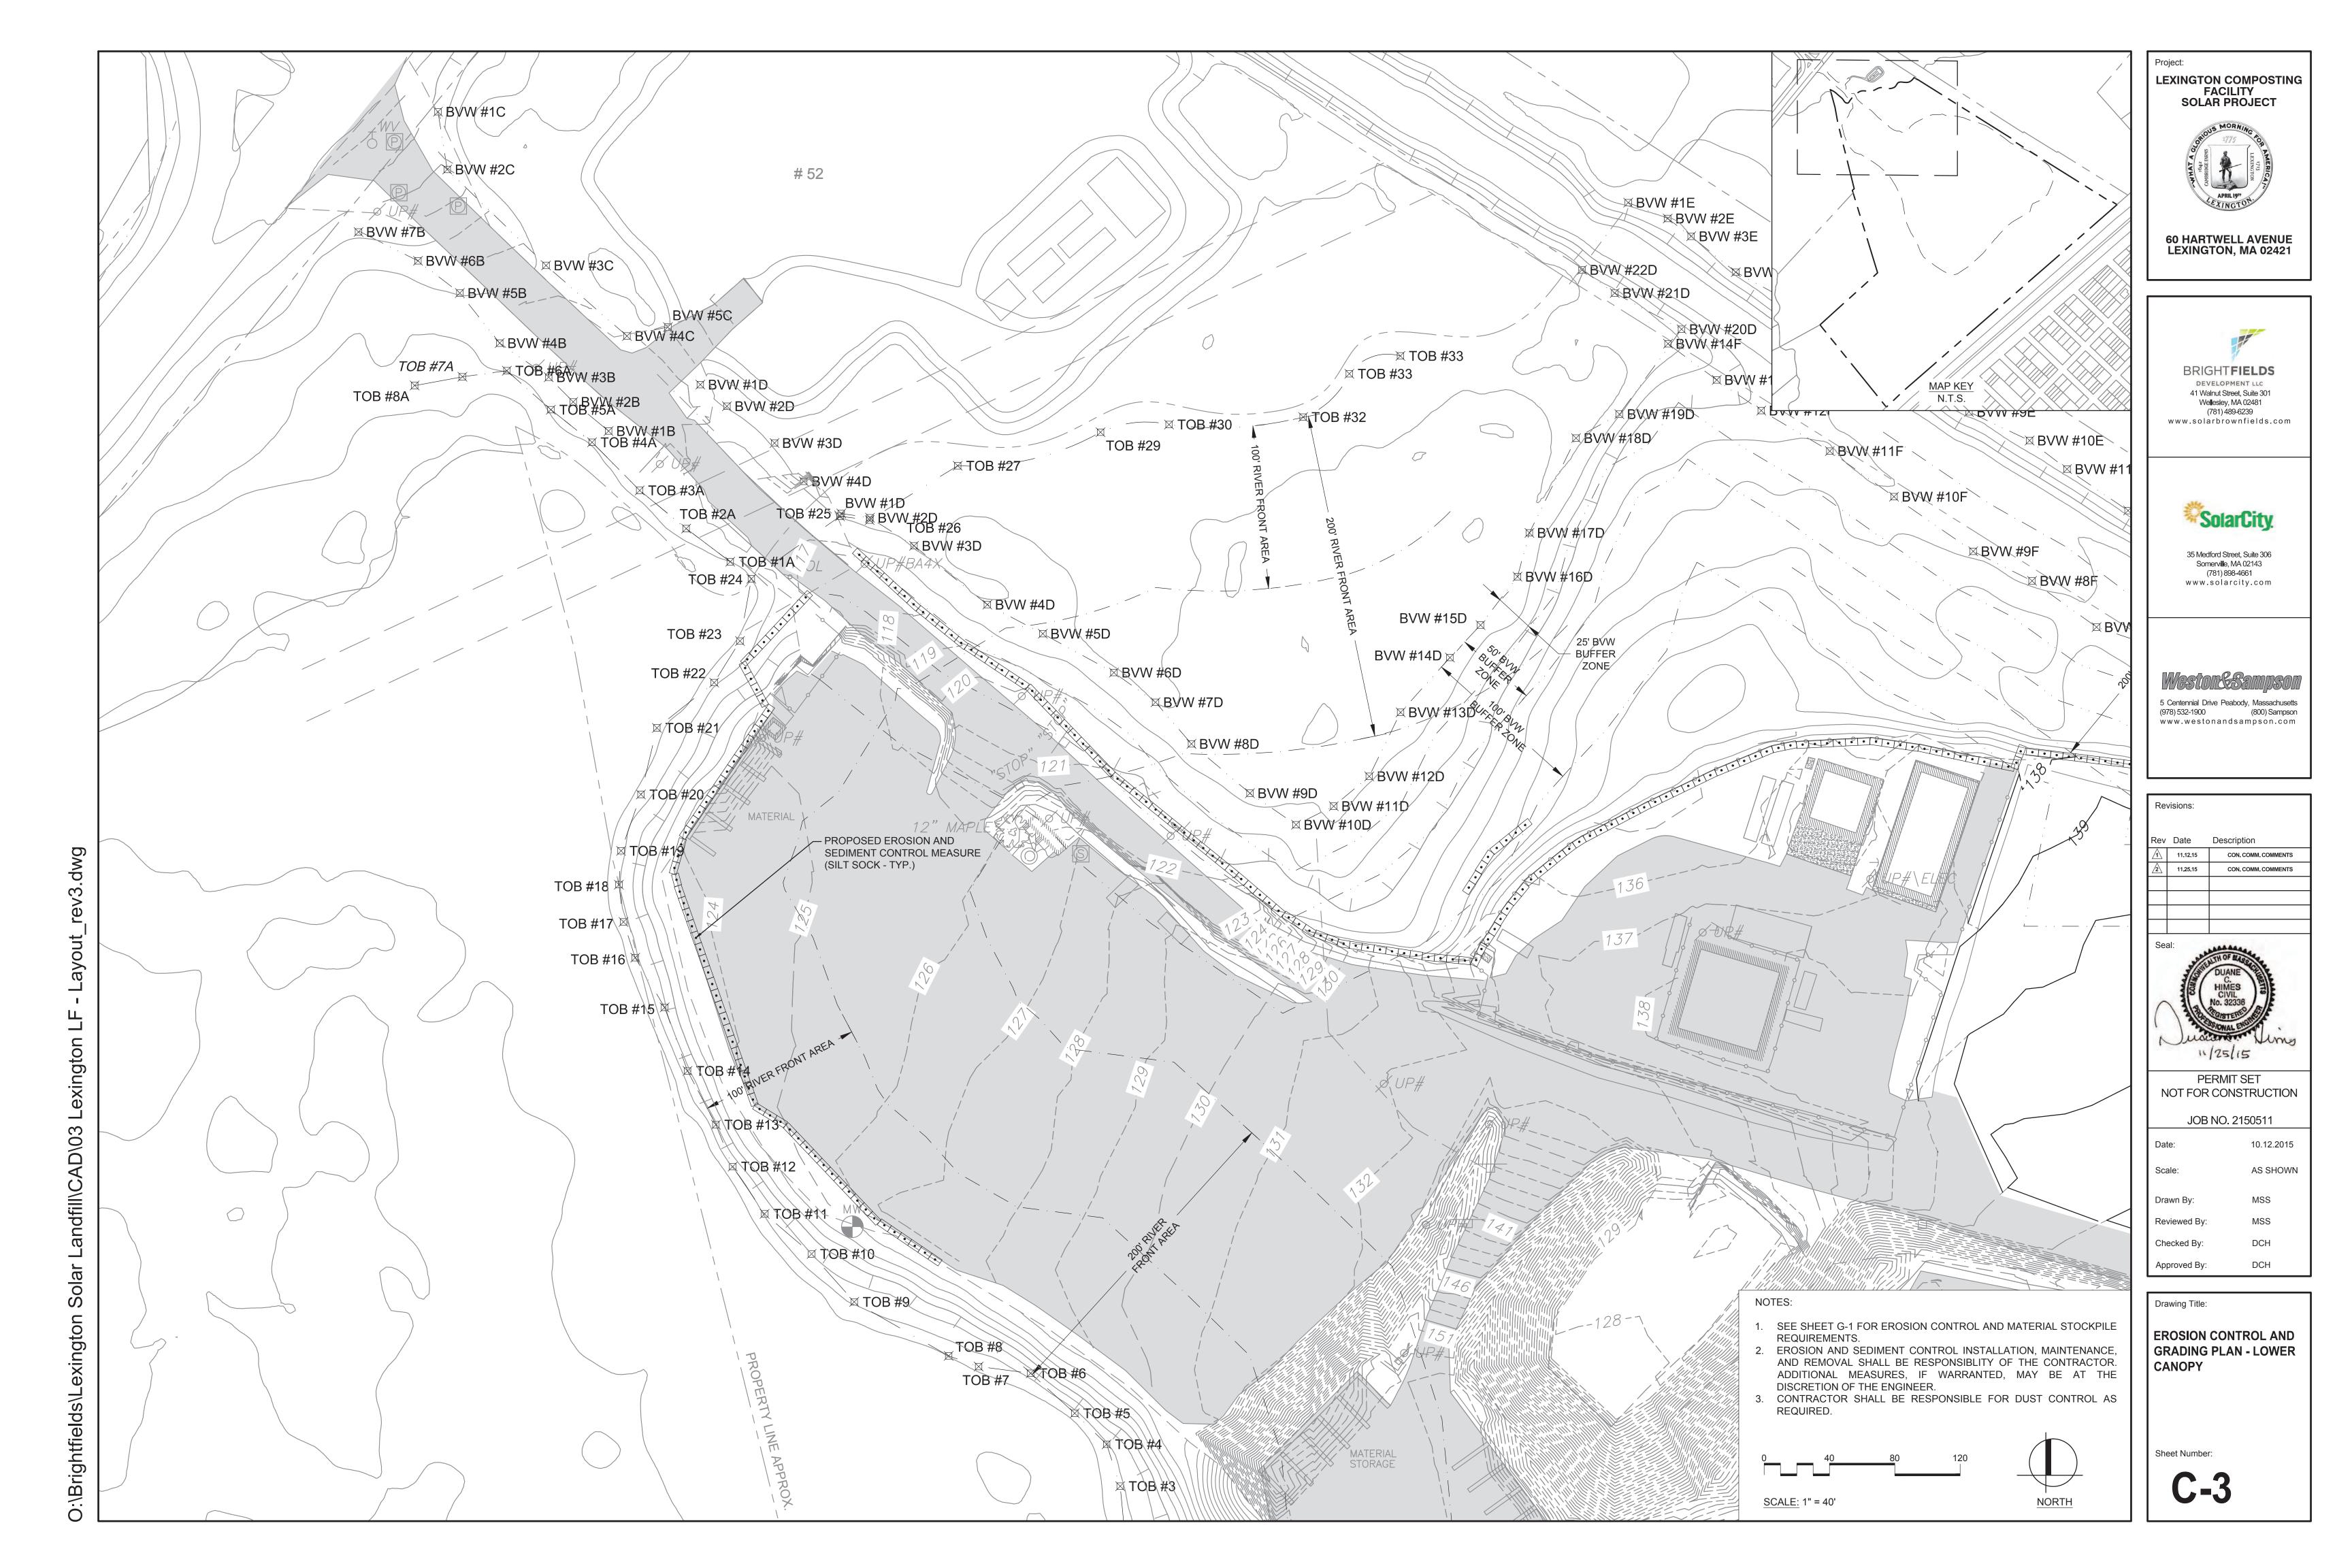
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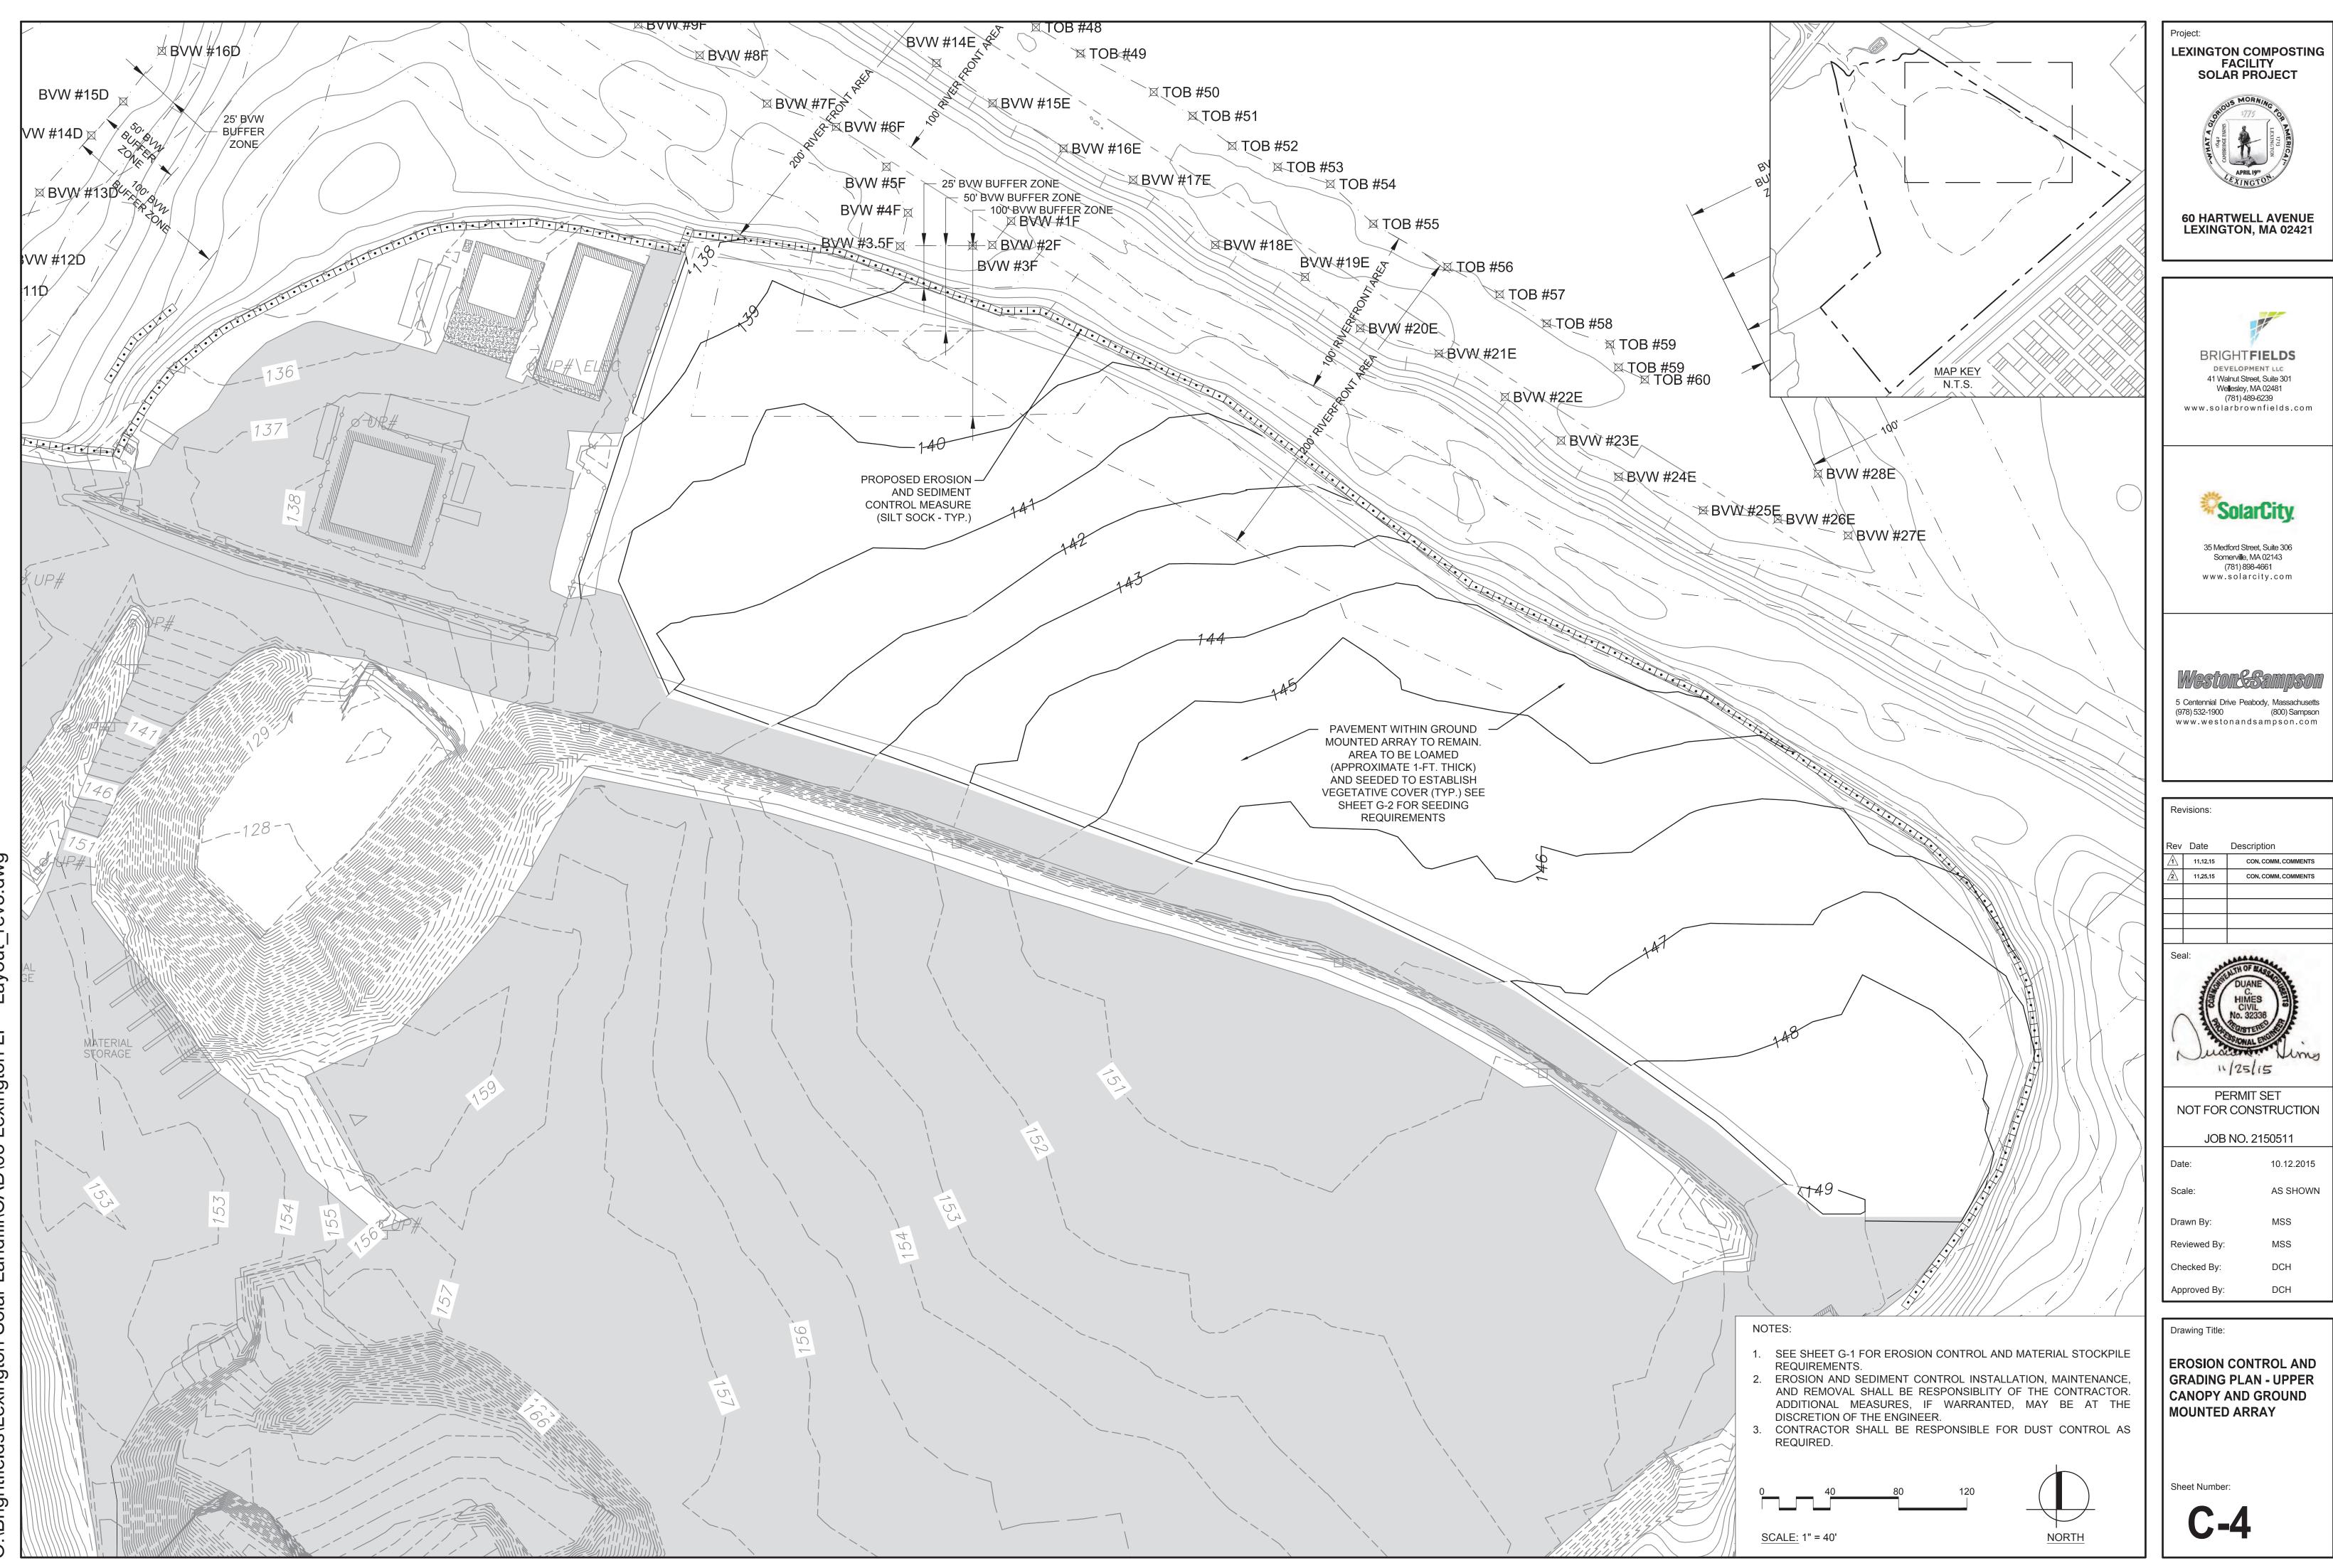
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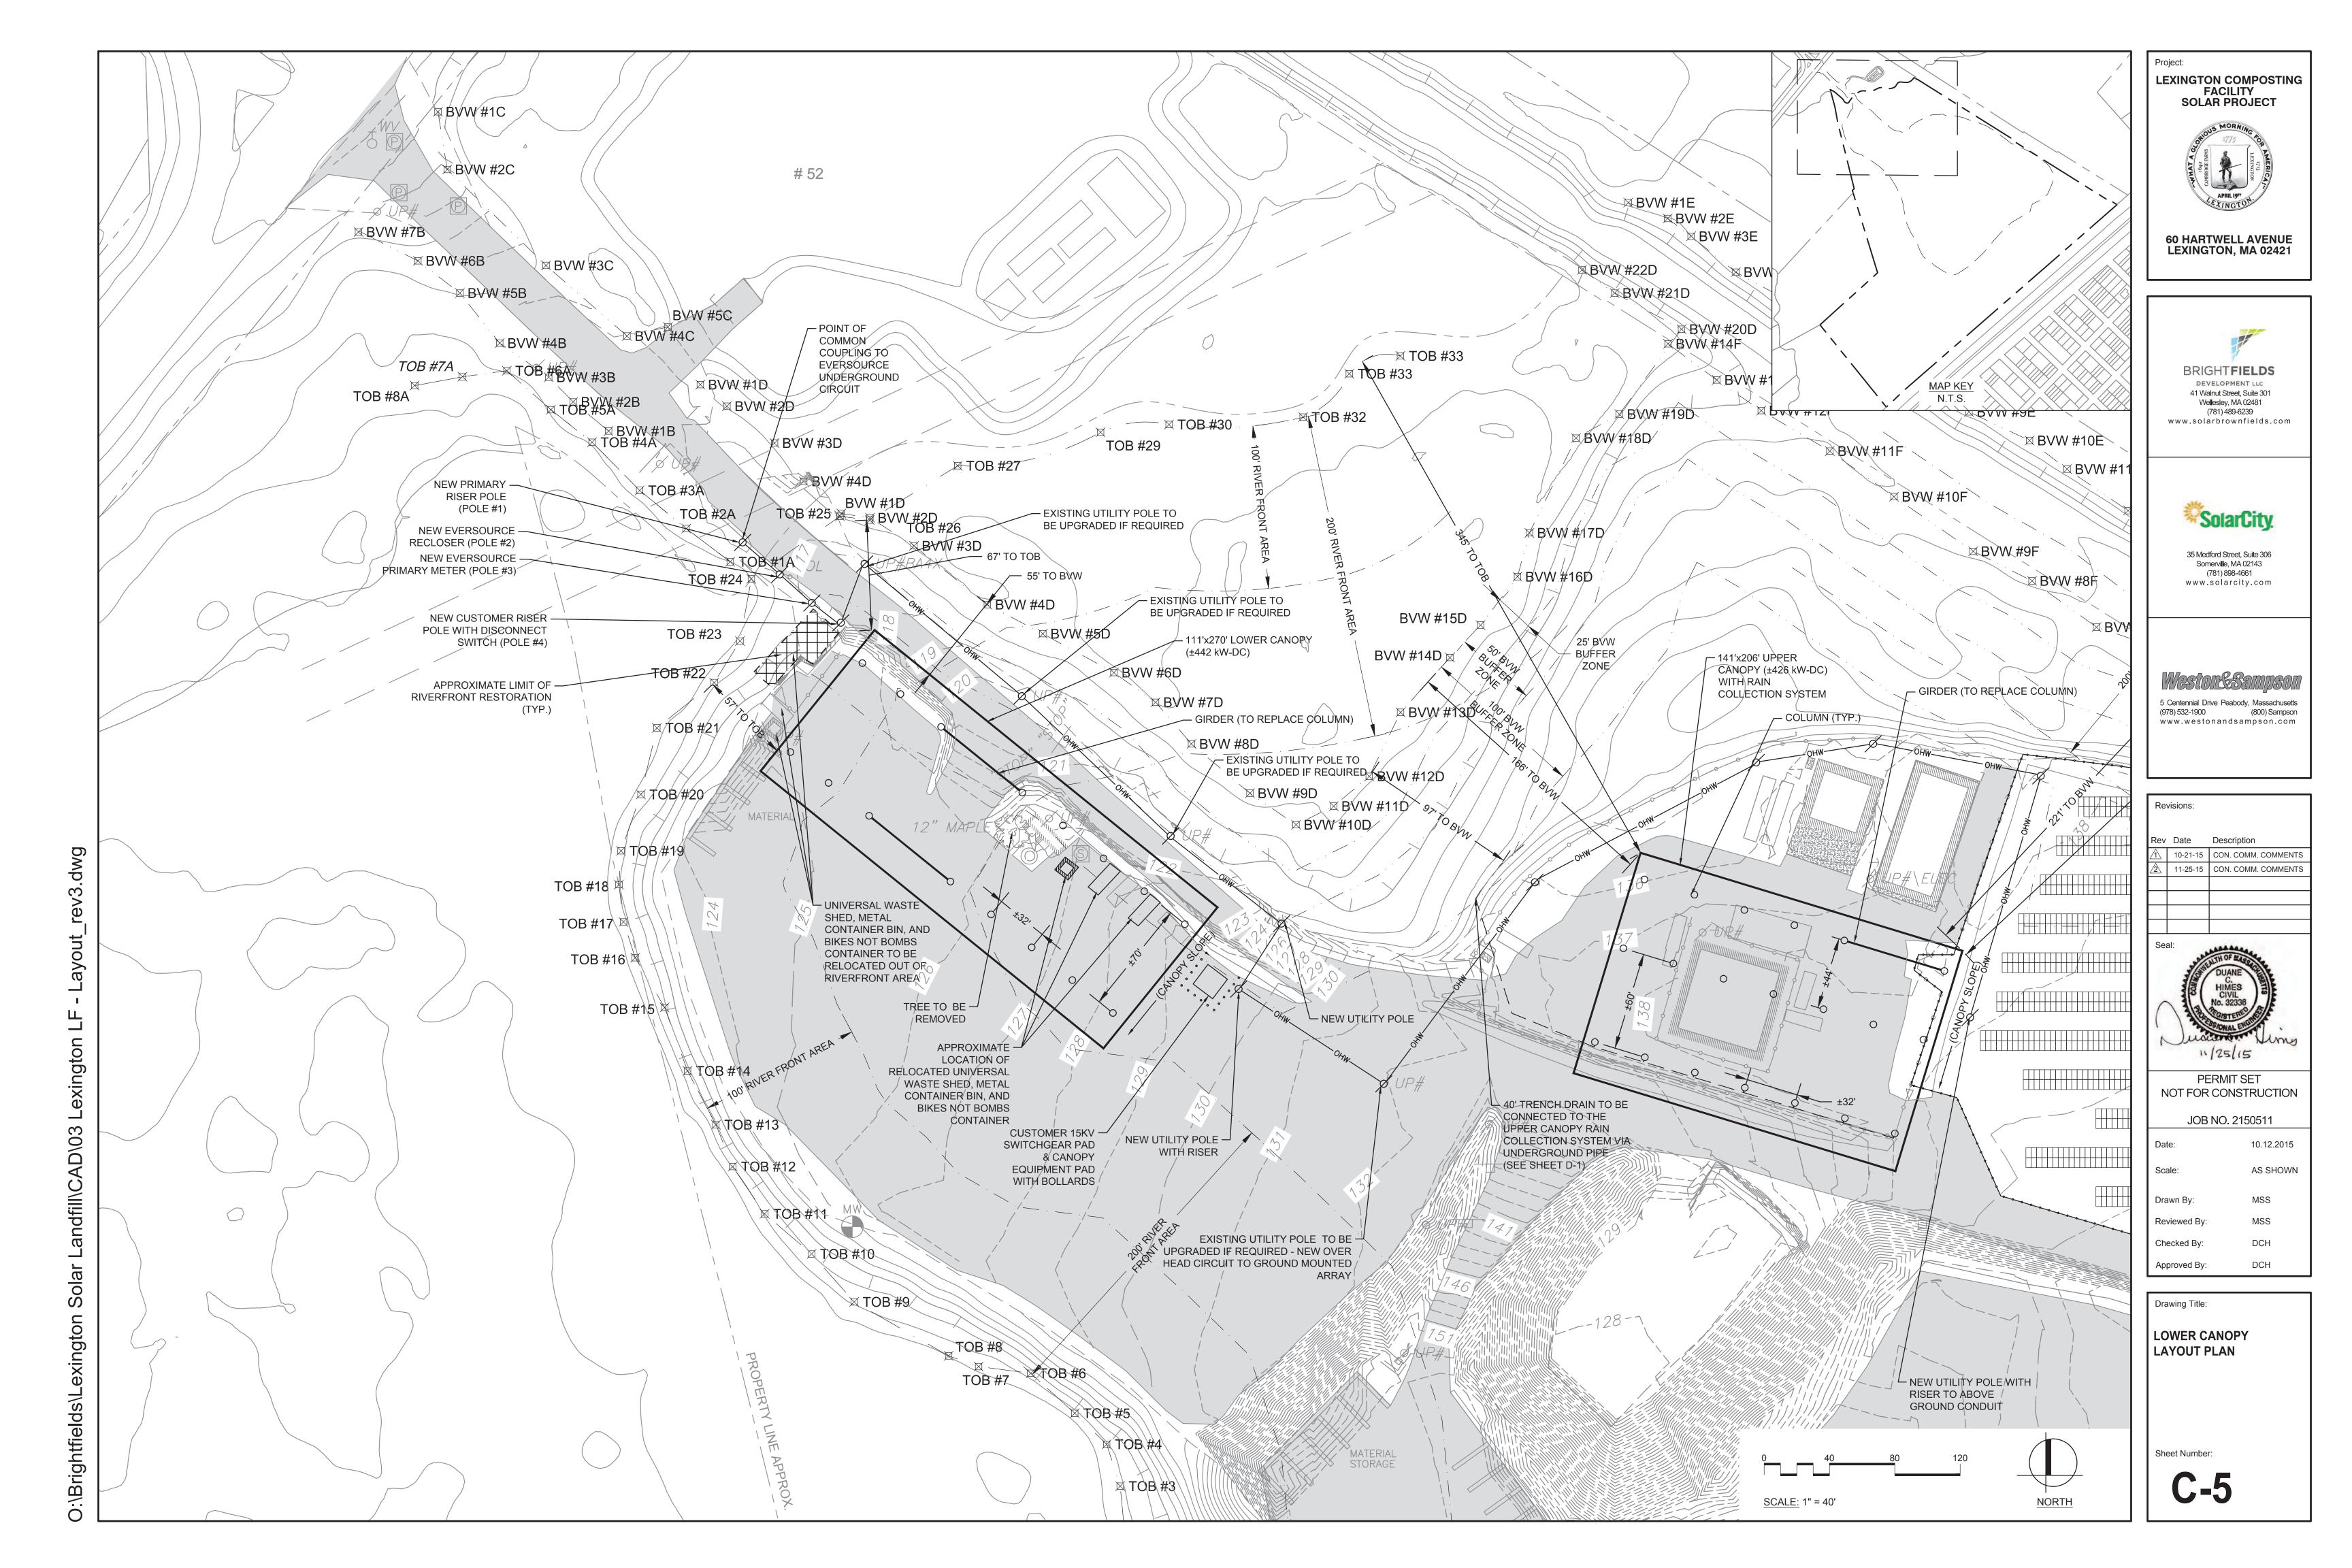
SURVEY PLAN


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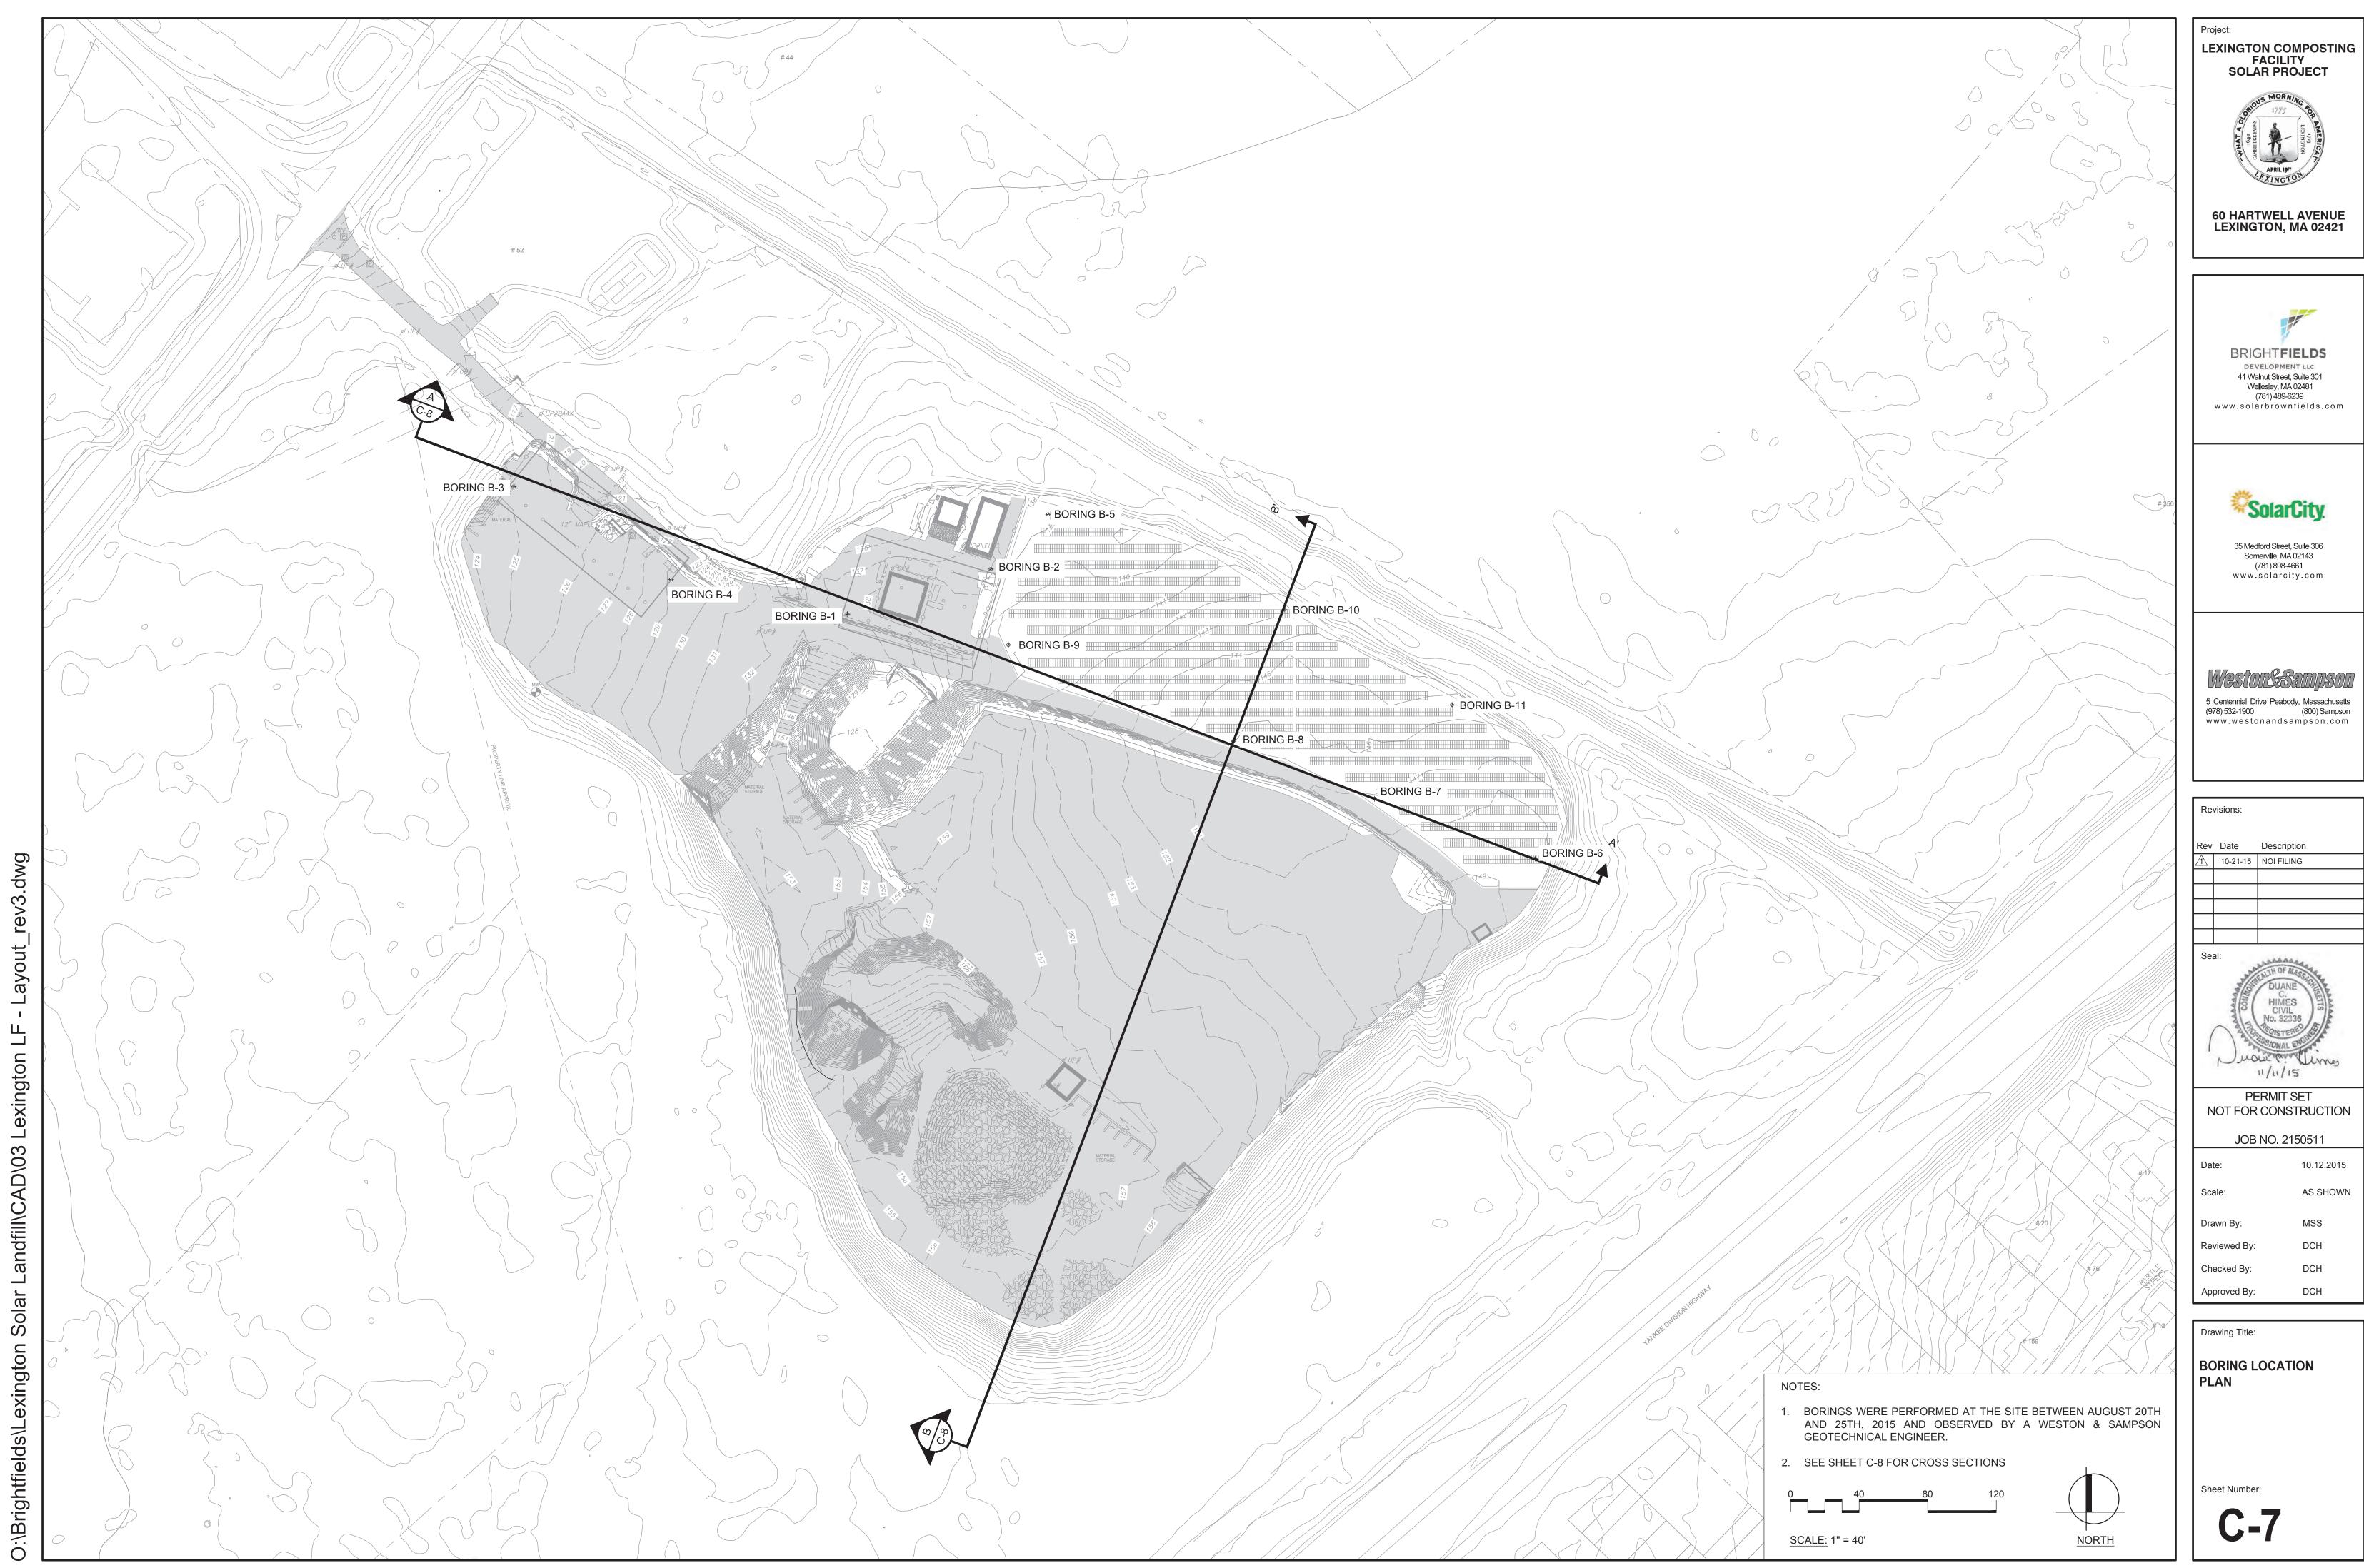
C-2











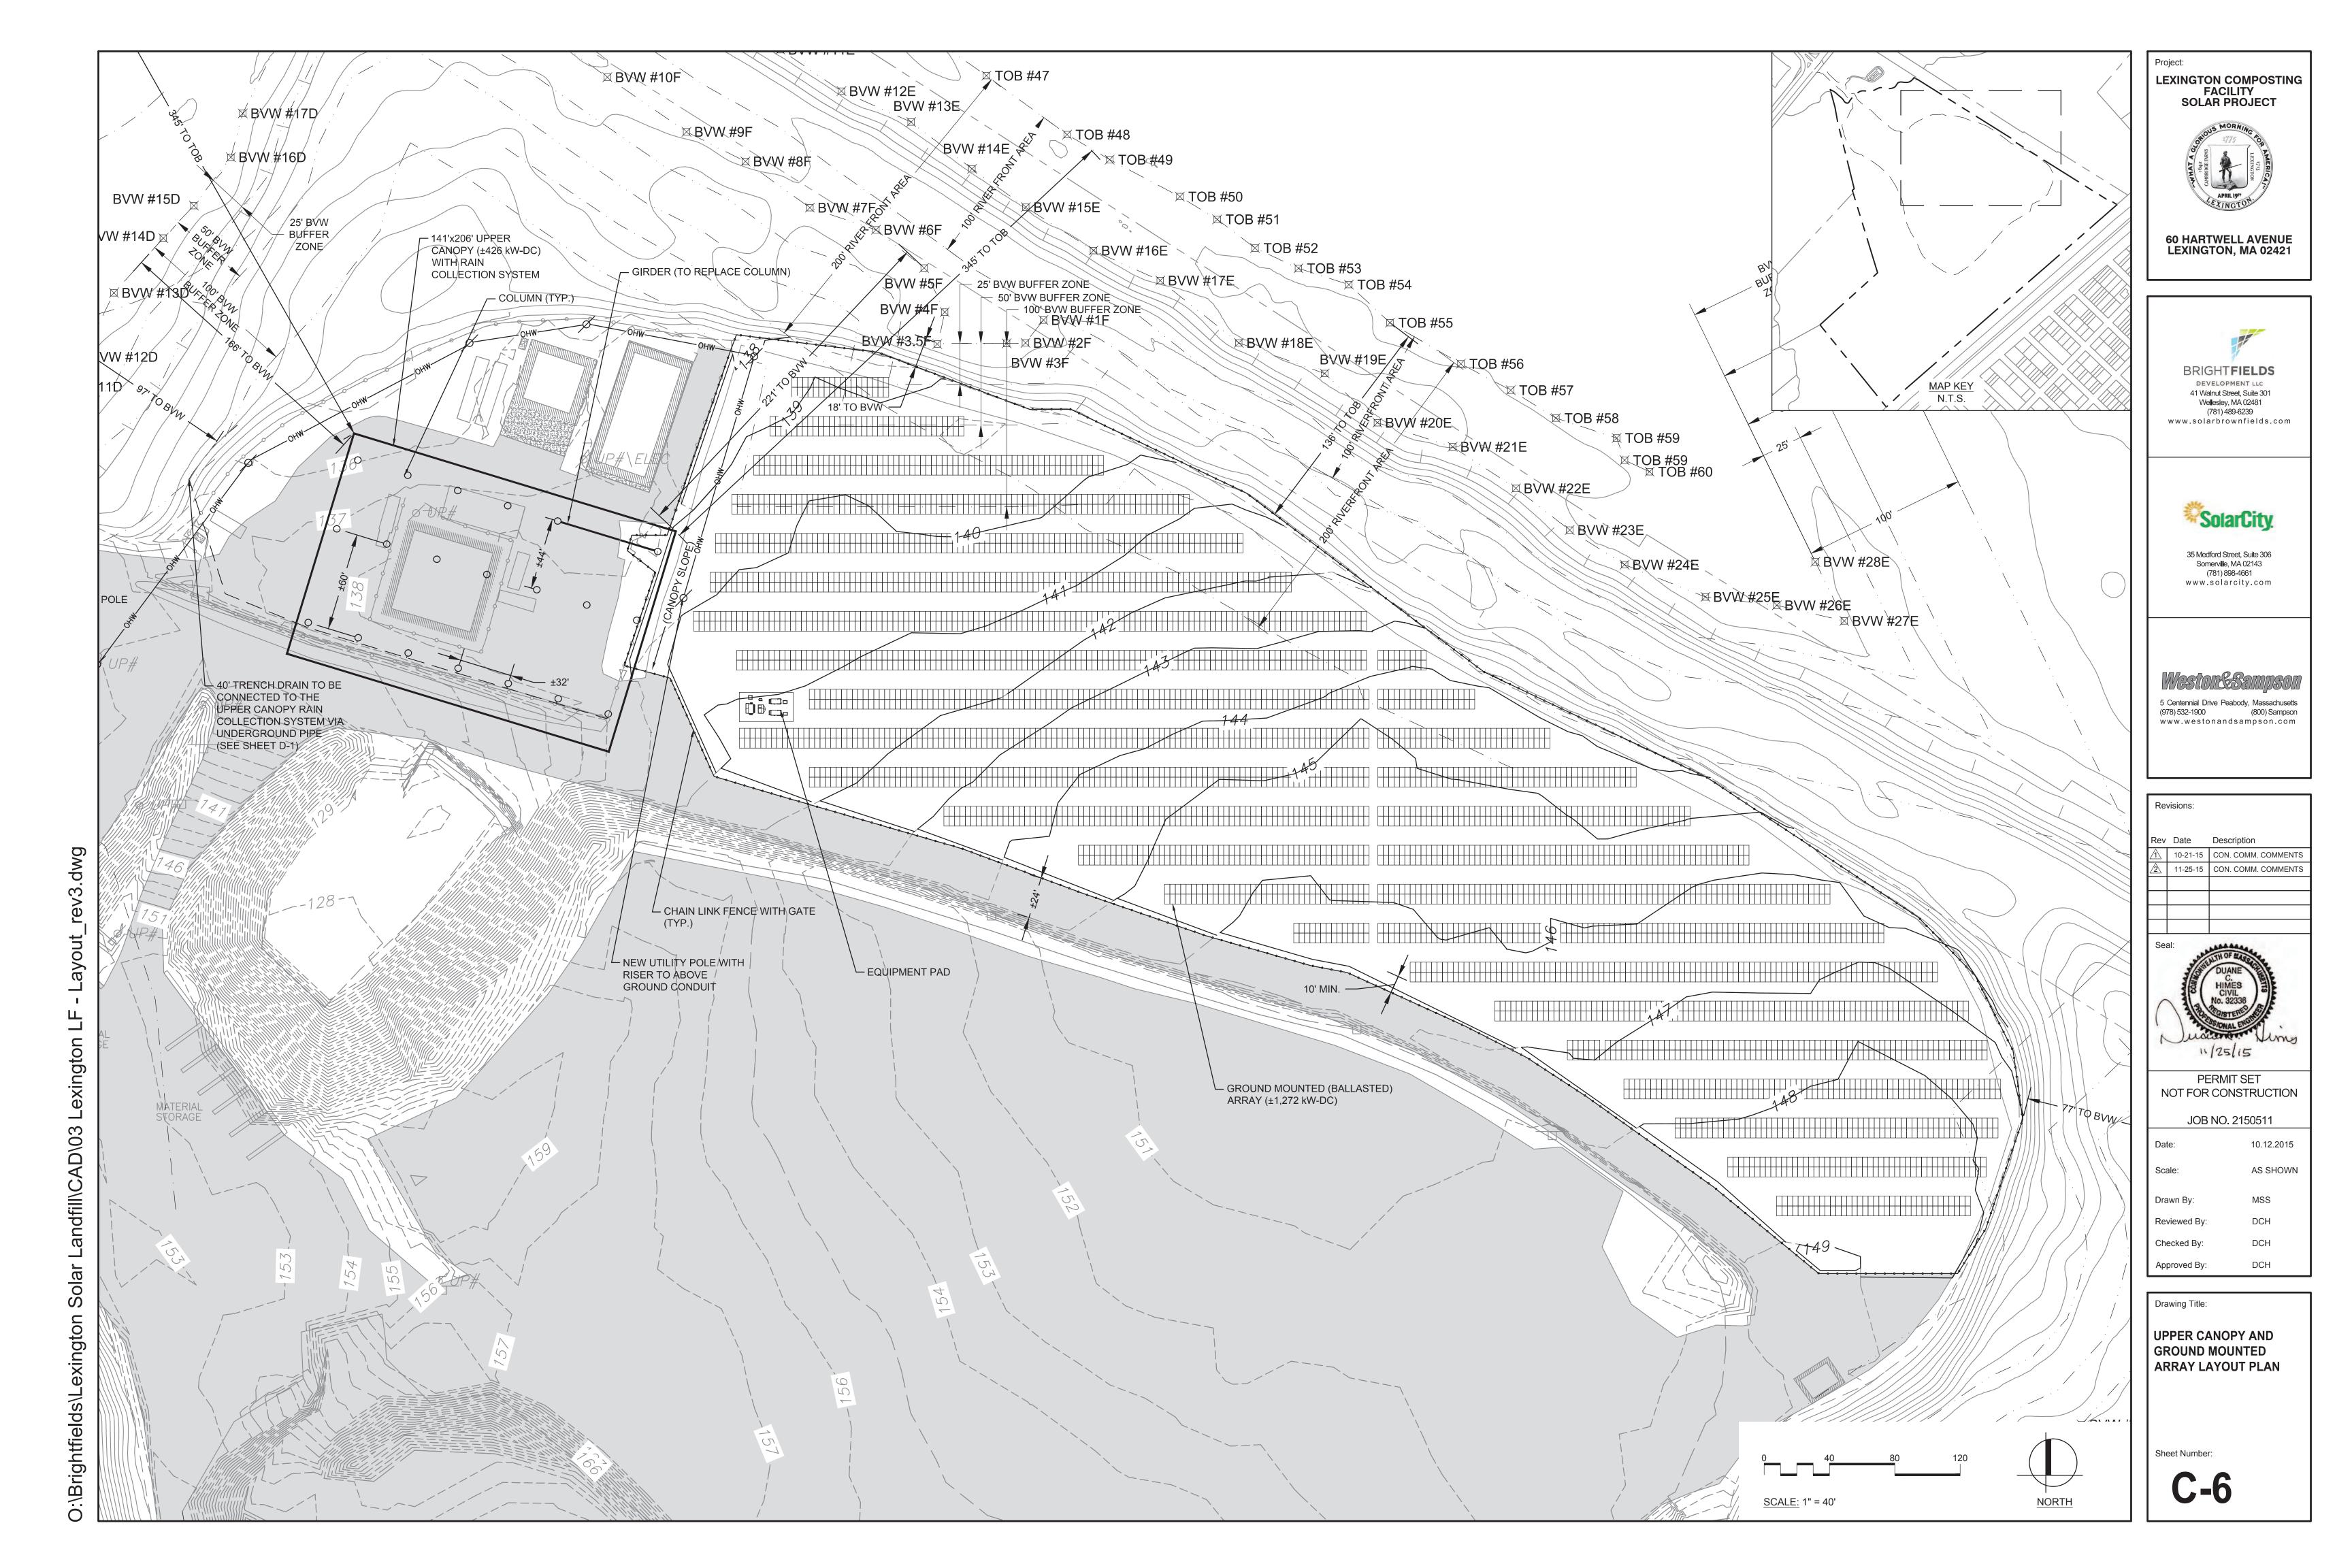

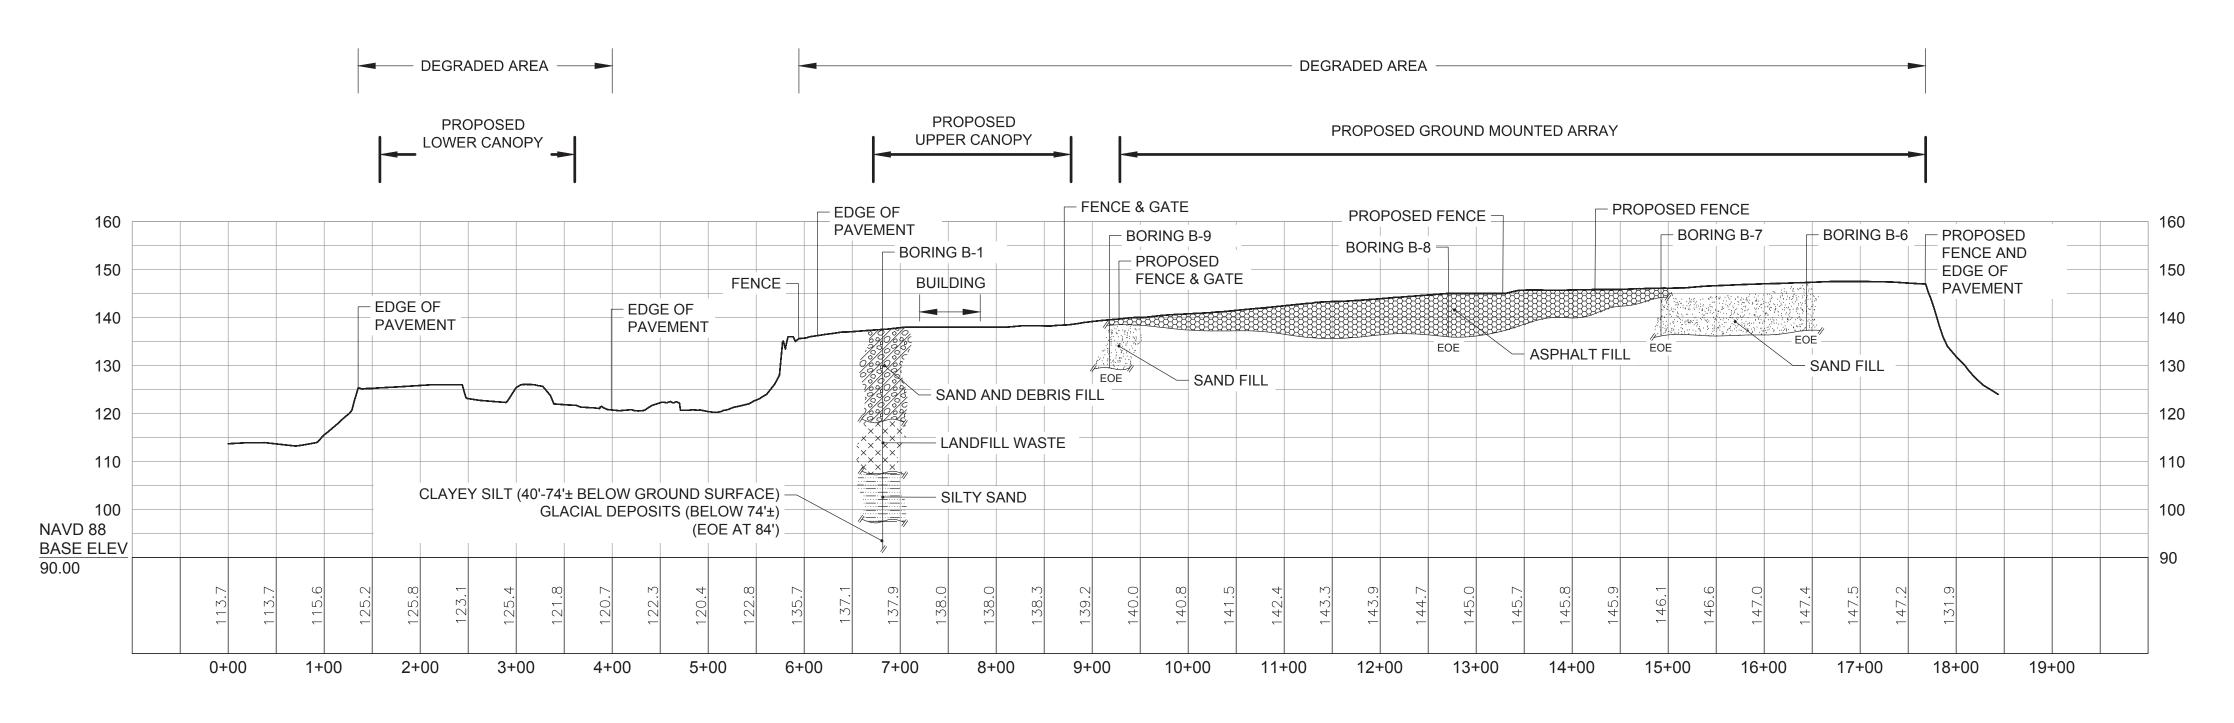

PROFILE A-A'

SCALE: 1" = 100' HORIZONTAL 1" = 20' VERTICAL

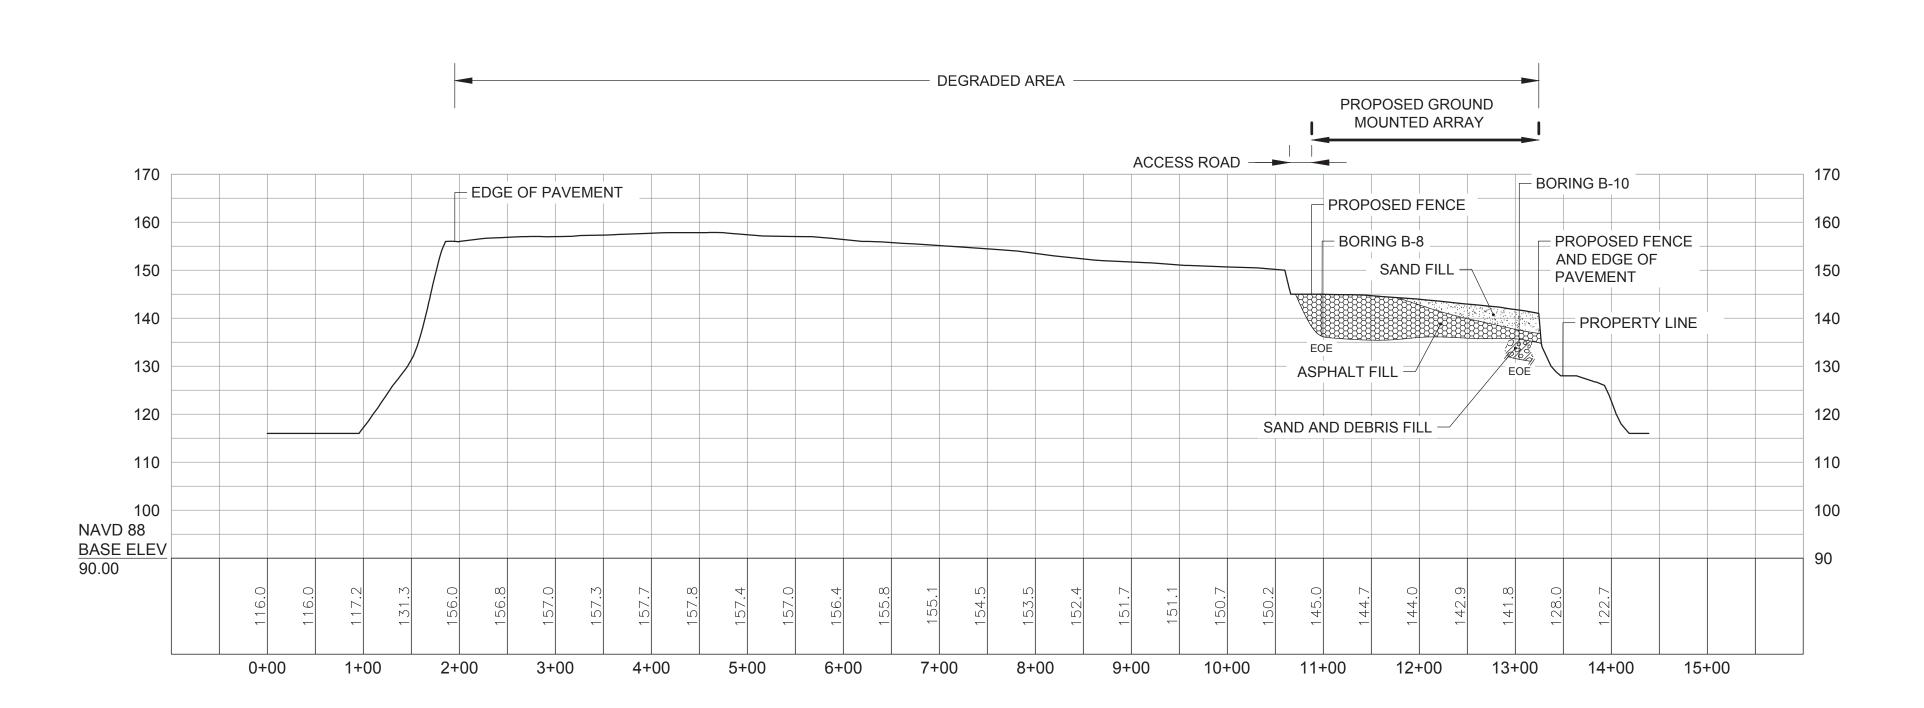

PROFILE B-B'

SCALE: 1" = 100' HORIZONTAL

1" = 20' VERTICAL

NOTES:

- 1. THE STRATIFICATION LINES REPRESENT THE APPROXIMATE BOUNDARY BETWEEN SOIL TYPES. TRANSITIONS MAY BE GRADUAL. SUBSURFACE CONDITIONS BELOW END OF EXPLORATION (EOE) DEPTHS ARE UNKNOWN.
- FINAL SYSTEM SIZE AND COMPONENTS ARE SUBJECT TO CHANGE. ALL DIMENSIONS AND DISTANCES ARE APPROXIMATE.
- 3. SEE SHEET C-7 FOR SECTION LOCATIONS.
- 4. SEE GEOTECHNICAL REPORT PREPARED BY WESTON & SAMPSON ENTITLED "GEOTECHNICAL INVESTIGATION, EVALUATION, AND FOUNDATION SUPPORT ALTERNATIVES LEXINGTON LANDFILL AND COMPOST FACILITY," DATED SEPTEMBER 24, 2015 FOR DETAILED INFORMATION ON SUBSURFACE CONDITIONS.

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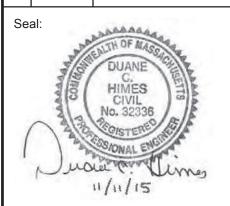


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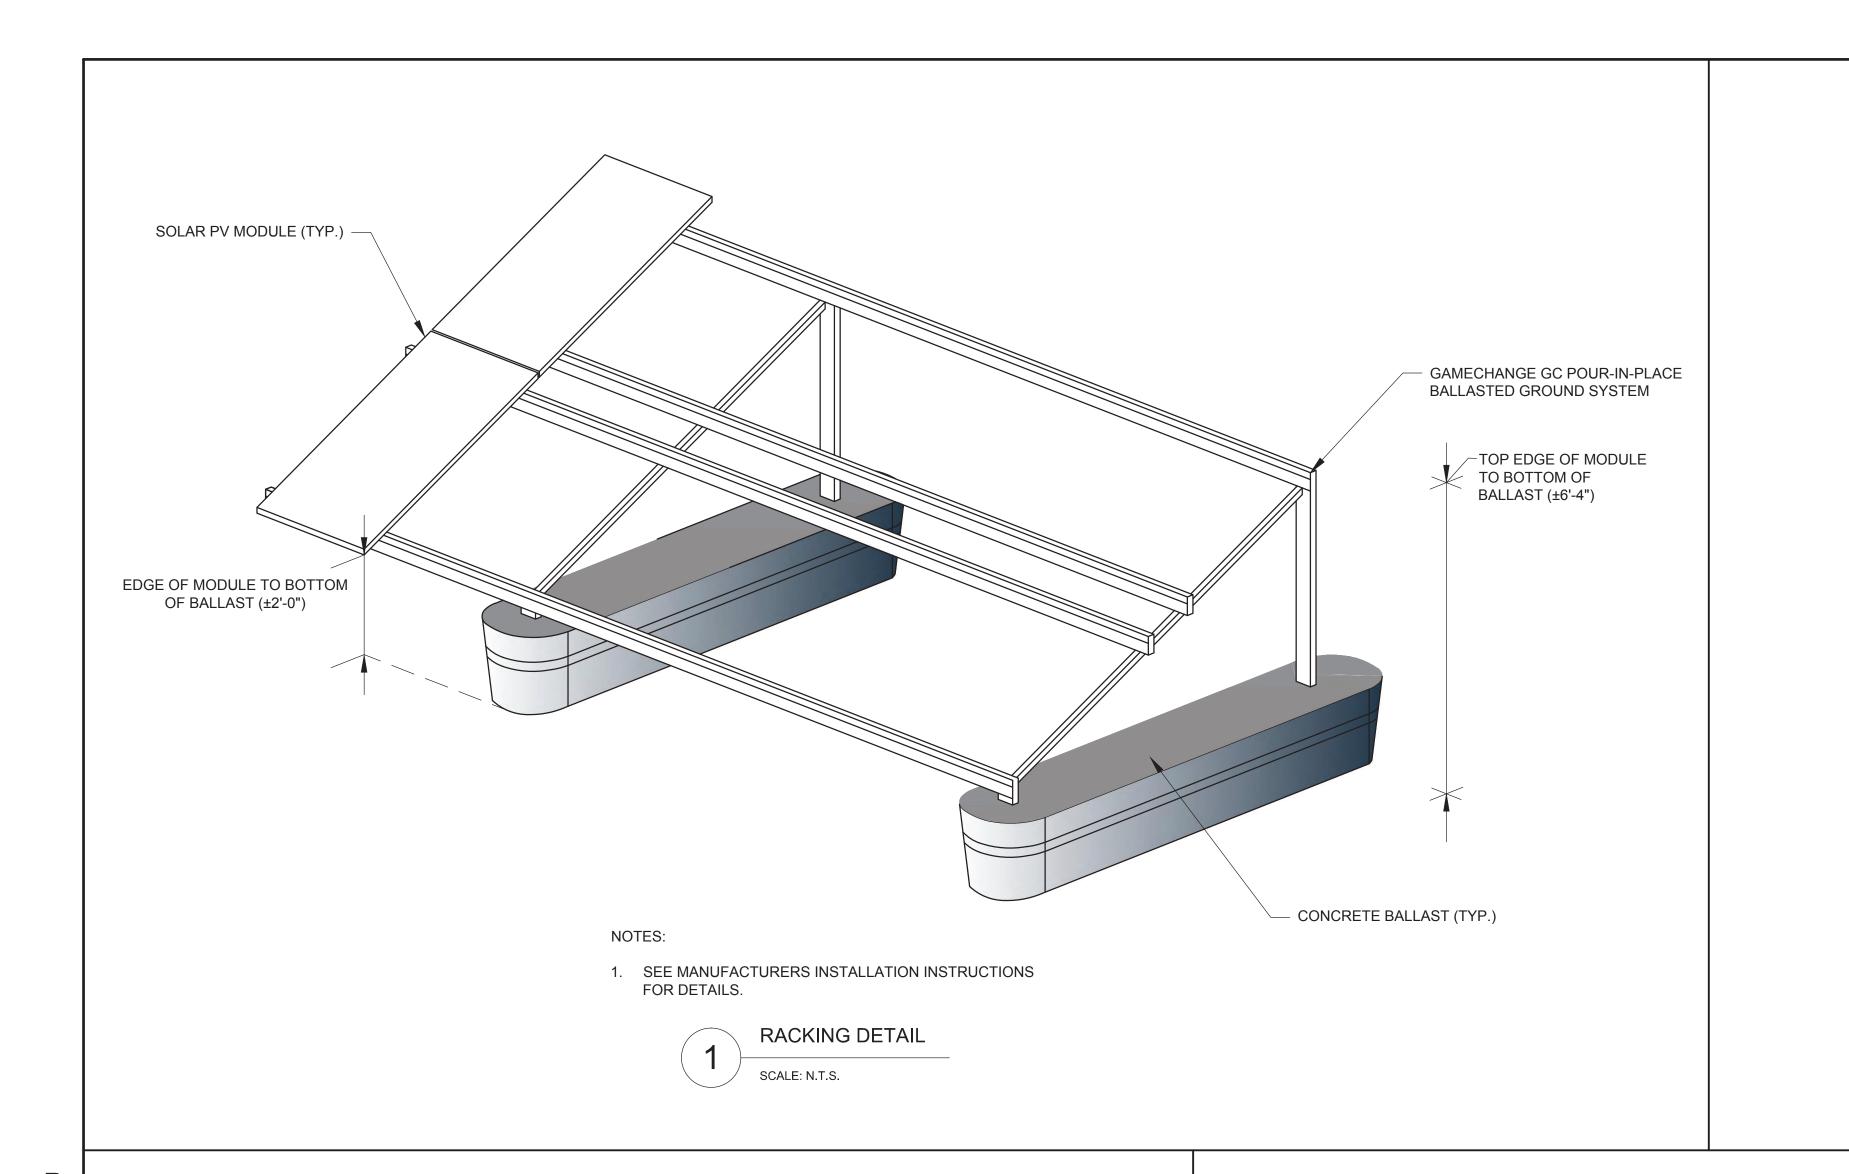
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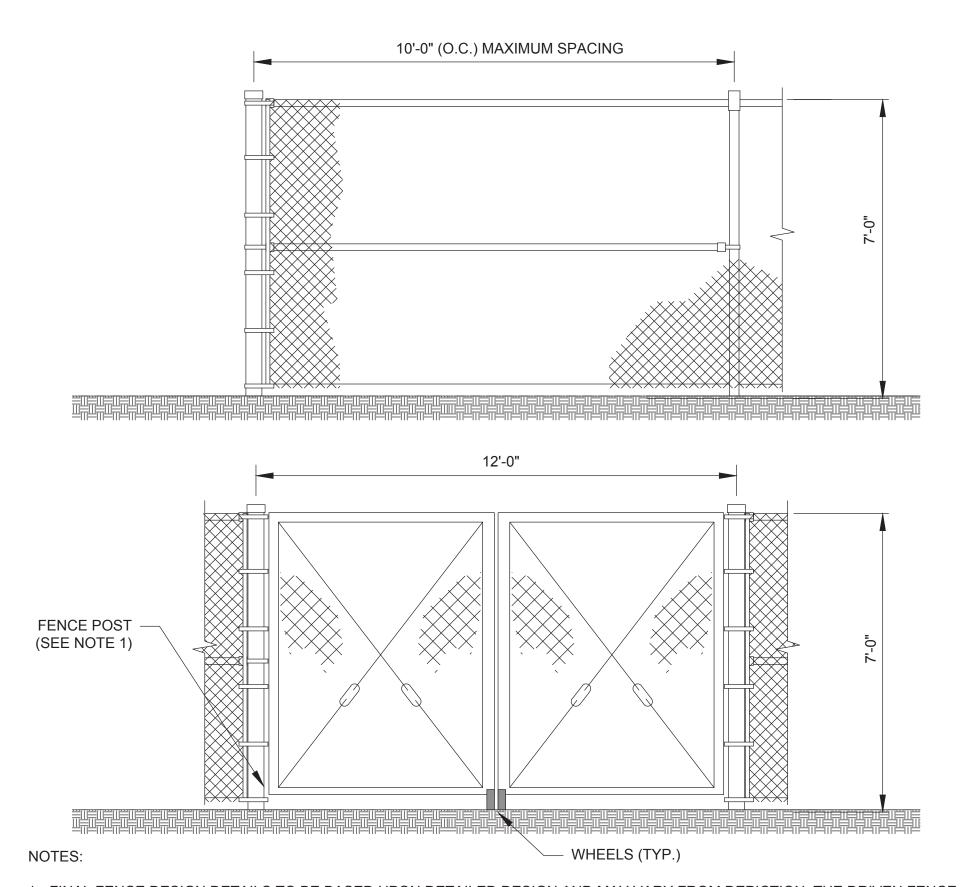
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SECTIONS PLAN

Sheet Number:

C-8






1. FINAL FENCE DESIGN DETAILS TO BE BASED UPON DETAILED DESIGN AND MAY VARY FROM DEPICTION. THE DRIVEN FENCE

POST METHOD IS PREFERRED, BUT DEPENDING ON SITE CONDITIONS, A BALLASTED FENCE MAY BE SUBSTITUTED.


2. ALL FENCING AND HARDWARE SHALL BE GALVANIZED.

TYPICAL CHAIN LINK FENCE AND GATE DETAIL SCALE: N.T.S.

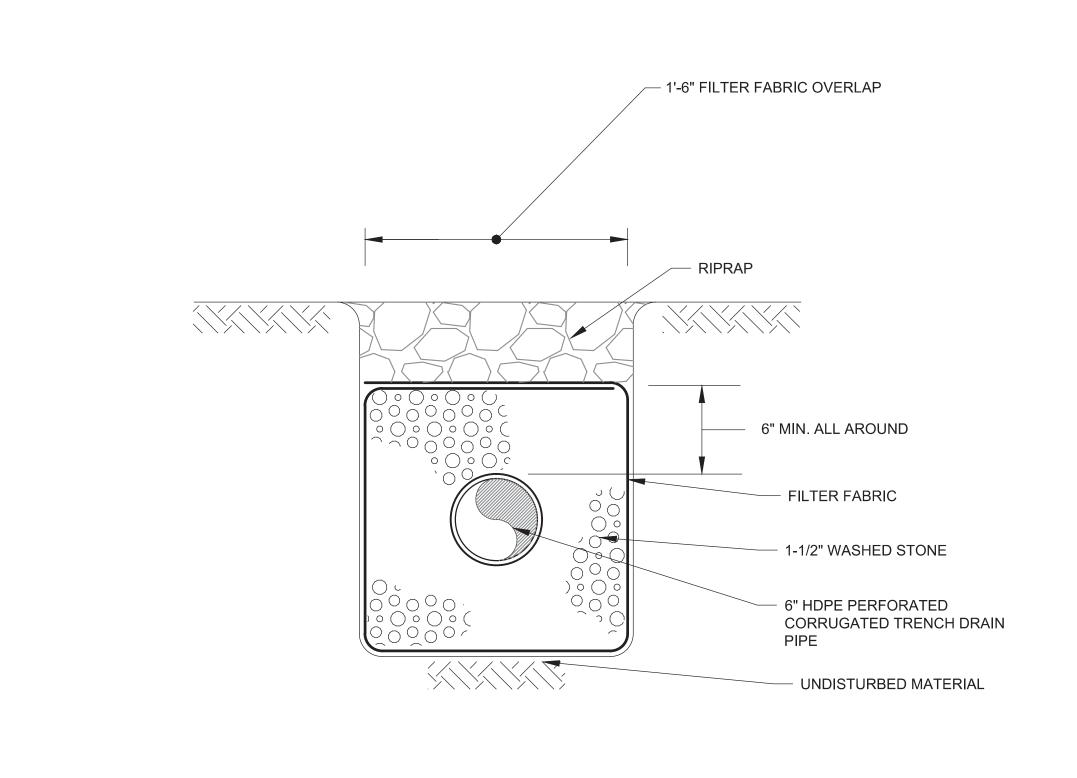

TYPICAL TRENCH DRAIN DETAIL


SCALE: N.T.S.

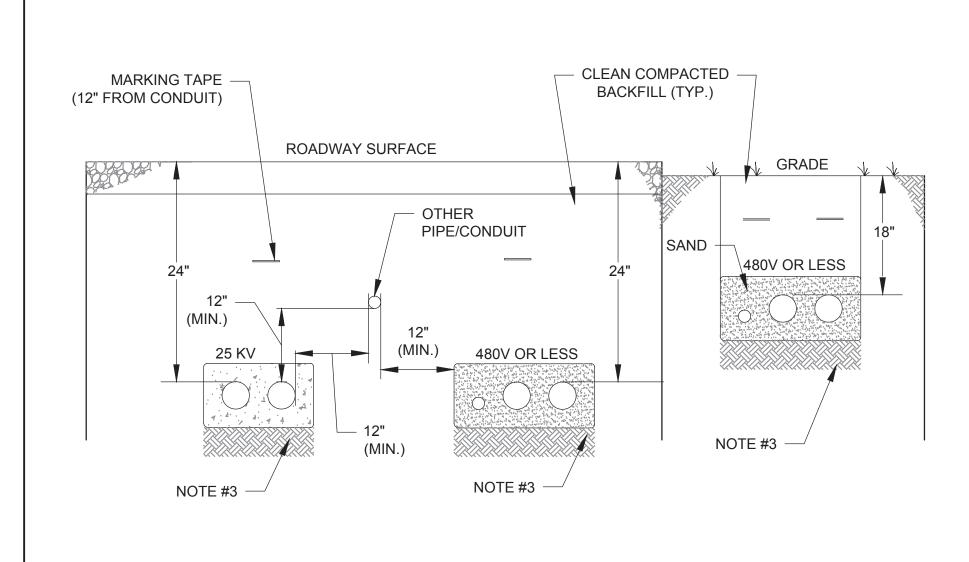

NOTES:


- 1. UNLESS OTHERWISE INDICATED, MAINTAIN DEPTH AND CLEARANCES AS INDICATED OR AS
- 2. THIS UNDERGROUND CONDUIT DETAIL WILL BE USED AT ALL OTHER UNDERGROUND
- INSTALLATIONS.
- 3. 4" DEEP COMPACTED SOIL TO BE INSTALLED UNDER CONDUIT.
- 4. FINAL ELECTRICAL EQUIPMENT AND DESIGN BASED ON EXISTING SITE CONDITIONS AND UTILITY REQUIREMENTS.



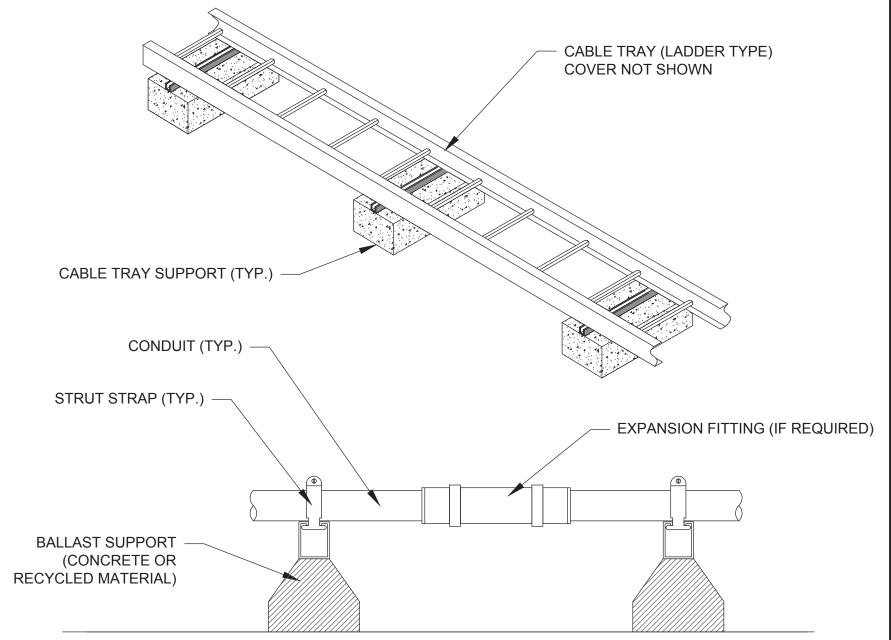

NOTES:

- 1. ALL CONDUIT/TRAY RELATED HARDWARE TO BE GALVANIZED.
- CONDUIT SUPPORTS SHALL BE SPACED PER THE NEC.
- 3. EXPANSION AND SPLICE FITTINGS SHALL BE INSTALLED PER THE NEC AND MANUFACTURERS
- 4. CONDUIT/TRAY TYPE AND DIMENSIONS SHALL BE BASED ON FINAL CONDUIT AND WIRE PLAN.
- 5. CRUSHED STONE TO BE ADDED BENEATH CONDUIT/CABLE TRAY SUPPORTS AS NEEDED TO
- LEVEL.
- 6. CONDUIT/TRAY AND SUPPORTS SHALL NOT BE INSTALLED SUCH THAT STORMWATER FLOW AND COLLECTION SHALL BE IMPACTED.
- 4. FINAL ELECTRICAL EQUIPMENT AND DESIGN BASED ON EXISTING SITE CONDITIONS AND UTILITY REQUIREMENTS.

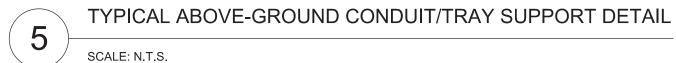



LEXINGTON COMPOSTING







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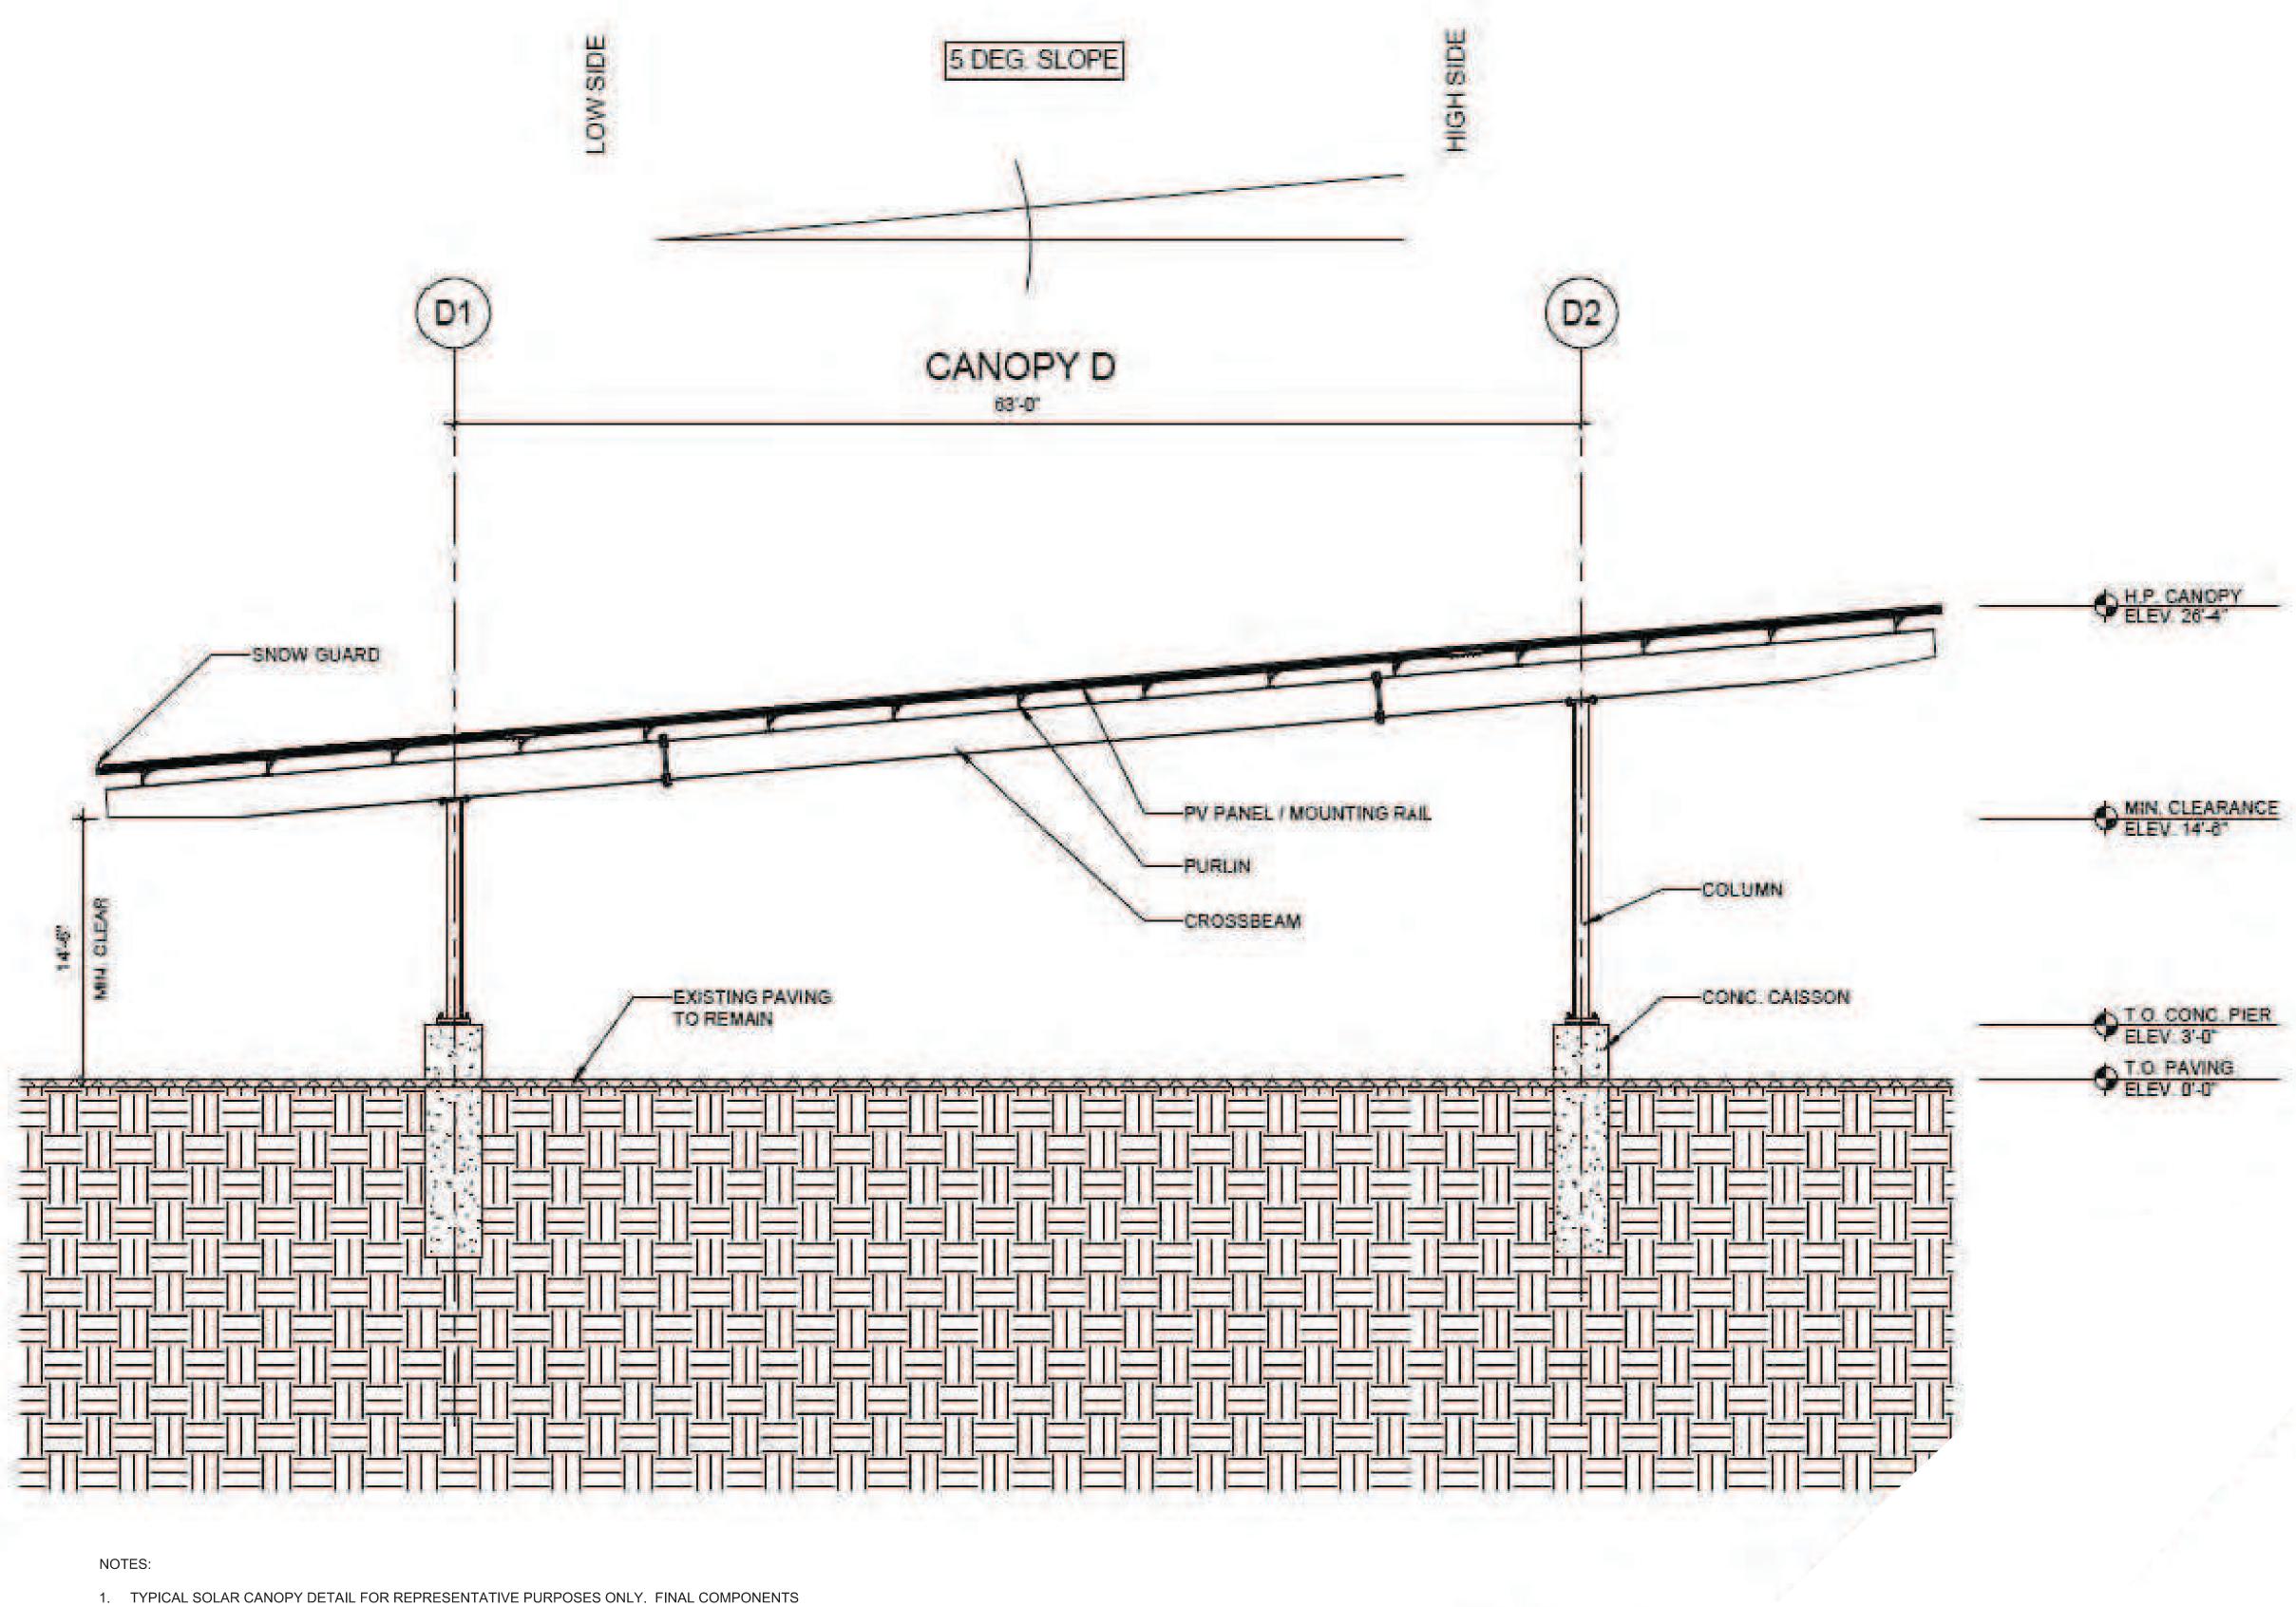
Scale:	AS SHOW
Drawn By:	MSS
Reviewed By:	MSS
Checked By:	DCH
Approved By:	DCH

Drawing Title:

TYPICAL DETAILS I

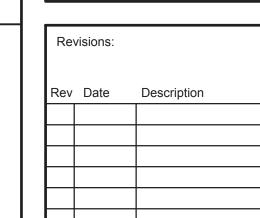Sheet Number:

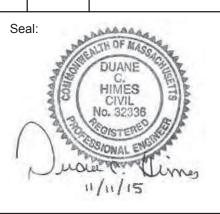D-1



AND CONFIGURATION SUBJECT TO CHANGE.

SOLAIRE GENERATION"

LONG SPAN 360 S

TYPICAL SOLAR CANOPY DETAIL (NORTH-SOUTH SECTION) 6

LEXINGTON COMPOSTING FACILITY SOLAR PROJECT

> **60 HARTWELL AVENUE LEXINGTON, MA 02421**



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AS SHOWN MSS MSS DCH Checked By: DCH

Drawing Title:

TYPICAL DETAILS II

Sheet Number:

D-2